
SCCOE BACKUP GENERATOR **BUILDING SUBMITTAL**

VICINITY MAP

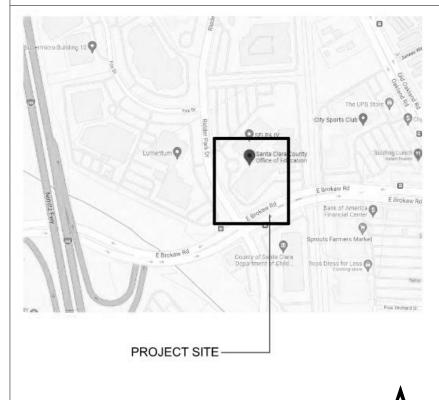

PROJECT DIRECTORY

ARCHITECT	ARTIK Art & Architecture 394-A Umbarger Road San Jose, CA 95111 (408) 224-9890
CLIENT	SANTA CLARA COUNTY OFFICE OF EDUCATION 1290 RIDDER PARK DRIVE MC 254 SAN JOSE, CA 95131-2304 (408) 453-6684
CIVIL ENGINEER	UNDERWOOD & ROSENBLUM, INC. 1630 OAKLAND ROAD, SUITE A114 SAN JOSE, CA 95131 (408) 453-1222
LANDSCAPE ENGINEER	ANLA ASSOCIATES, INC. 1213 LINCOLN AVE, SUITE 211 SAN JOSE, CA 95125 (408) 292-2196
STRUCTURAL ENGINEER	DUQUETTE ENGINEERING 1171 HOMESTEAD ROAD, SUITE 275 SANTA CLARA, CA 95050 408-615-9200
ELECTRICAL ENGINEER	AEC ALIANCE ENGINEERING CONSULTANTS, INC. 4701 PATRICK HENRY DRIVE BUILDING 10 SANTA CLARA, CA 95054 (408) 970-9888

GENERAL NOTES

- Existing construction data shown on the drawings was obtained from available drawings. The contractor shall verify all existing conditions and shall notify the architect of all exceptions before proceeding with the work.
- See architectural drawings for layout dimensions and elevations except where indicated otherwise. All discrepancies between drawings shall be clarified with
- the architect prior to proceeding with work. In the event that certain features of the construction are not fully shown or detailed on the drawings or called for in the
- general notes, then their construction shall be of the same character as similar conditions that are shown or called for. Dimensions, elevations, and existing conditions shall be checked and verified on the job site by each contractor. Errors, omissions or discrepancies shall be reported to the
- architect before work begins or supplies are ordered. Verify electrical, mechanical, fire alarm, telephone and security requirements before construction begins.
- Work shall be performed in conformance with local, county, state and federal codes, laws, and regulations
- applicable to this work. Any item identified to be demolished, removed or relocated is to be completely removed, including but not limited to any concealed items (pipes, curbs, framing, beams, fasteners, etc.). All items within a demolished area that must be rerouted in order to maintain continuity shall be done so in accordance with appropriate specification sections in the project manual at no additional cost. If no specification can be found within the project manual, then continuity shall be maintained by current standard methods for construction but not lesser in quality than existing. Any area of demolition or removal shall be left in a completely
- finished condition as outlined in the project manual. 9. All case work to be attached to walls and floors as indicated on drawings. If no specific detail is referenced, use the details referenced for similar conditions on other casework.
- 10. Food handling facilities shall comply with local/ county health department requirements. 11. On Architectural, Civil, Landscape, and Plumbing sections,
- materials and their installation shall comply with applicable codes, standards, and manufacturer's recommendations. 12. Per CBC 11B-104.1, All dimensions are subject to conventional industry tolerances except where the
- requirement is stated as a range with specific minimum and maximum end points.

GOVERNING CODES

LIST OF 2019 CALIFORNIA CODE OF REGULATIONS (C.C.R.) as of January 1, 2019:

- 2019 California Administrative Code (CAC), Part I, Title 24 C.C.R
- 2019 California Building Code (CBC) Part 2, Title 24 C.C.R. (2015 International Building Code with 2019 California Amendments) 2019
- California Electric Code (CEC), Part 3, Title 24 C.C.R. (2014 National Electric Code with 2019 California Amendments) 2019 California Mechanical Code (CMC), Part 4, Title 24
- C.C.R. (2015 Uniform Mechanical Code with 2019 California Amendments) California Plumbing Code (CPC), Part 5, Title 24 2019
- C.C.R. (2015 Uniform Plumbing Code with 2019 California Amendments) California Energy Code (CEnC), Part 6, Title 24 2019 C.C.R.
- 2019 California Historical Building Code (CHBC), Part 8, Title 24 C.C.R. (2019 California Amendments) California Fire Code (CFC), Part 9, Title 24 C.C.R. 2019
- (2015 International Fire Code with 2019 California Amendments) California Existing Building Code (CEBC). Part 10, 2019 Title 24 C.C.R. (2015 International Existing Building
- Code and 2019 California Amendments) 2019 California Green Building Standards Code (CALGreen), Part 11, Title 24 C.C.R. California Referenced Standards Code, Part 12, Title 2019
- 24 C.C.R. Title-19 (C.C.R.), Public Safety, State Fire Marshal Regulations. 2013 ASME A17.1/CSA B44-13 Safety Code for Elevators and Escalators


SYMBOL LEGEND

Room Name CLASSROOM A101 Room Number Room Area <01> DEMOLITION KEY NOTE NUMBER (01) $\langle \mathsf{A} \rangle$ PARTITION TYPE 36∕~34 <100> √24 CASEWORK IDENTIFICATION + 10'-0" **CEILING HEIGHT** $\langle A \rangle$ WINDOW TYPE (A101.1)


A.F.F. ARCH. ASSEM. BD. BLDG. BLKG. CAB. C.B. CER. C.J. CLR. CLR. CONC. CONF. CONC. CONF. CONF. CONC. CONF. CONC. CONF. CONC. CONF. CONC. CONF. CONC. CONF. CONT. CONT. CONT. CONT. CONC. CONT.	ASPHALT CON ACCESSIBLE ABOVE FINISH ARCHITECTUR ASSEMBLY BOARD BUILDING BLOCK BLOCKING CABINET CATCH BASIN CEMENT CERAMIC CAST IRON CONTROL JOIN CENTER LINE CLEAR CAULKING COLUMN CONCRETE CONFERENCE CONFERENCE CONFERENCE CONFERENCE CONFERENCE CONFERENCE CONFERENCE CONFERENCE CONFERENCE CONFERENCE CONFERENCE CONFERENCE CONTINUOS CORRIDOR CEMENT PLAS SYSTEM COUNTERSINH CENTER DOUBLE DRINKING FOL DETAIL DIAMETER DIMENSION DOWN DOOR DOWNSPOUT DRAWING EACH EXPANSION JO ELECTRICAL EQUAL EXISTING EXTERIOR EXTERIOR EXTERIOR
DN.	DOWN
DR.	DOOR
DWG.	DRAWING
EA.	EACH
ELEC.	ELEVATION ELECTRICAL
(E)	EXISTING
EXT.	EXTERIOR
EXP. F.A. F.D. FDN.	FIRE ALARM FLOOR DRAIN FOUNDATION
F.E. F.H. FHWS	FIRE EXTINGU FIRE HYDRANT
FIN.	FINISH
F.F.	FINISH FLOOR
F.P.	FIRE PROTECT
FT.	FOOT
GA.	GAUGE
GALV.	GALVANIZED
G.B.	GRAB BAR
G.I.	GALVANIZED II
G.W.B.	GYPSUM WALI

1290 Ridder Park Dr, San Jose

SHEET INDEX SCOPE OF WORK ROOM IDENTIFICATION INSTALLATION OF TWO 600 KW BACKUP GENERATORS - S1-SOUTH GENERATOR, CONCRETE PAD, 10' WALL ENCLOSURE, AND S-2 ARCHITECURAL NORTH GENERATOR, CONCRETE PAD. 8' TALL FENCE ENCLOSURE 1 GRID (MTS CONCRETE PAD AND ASSOCIATED ELECTRICAL, LANDSCAPE A0.01 TITLE SHEET IDENTIFICATION AND CIVIL SITE WORK. A1.10 OVERALL SITE PLAN A1.11 DEMOLITION SITE PLAN A2.10 **BUILDING SECTION** A2.11 A8.01 A8.02 A12.11 SITE DETAILS **KEY NOTE NUMBER** ์ 1 ____ DETAIL CUT A12.12 SITE DETAILS A12.01 A12.32 EXTERIOR DETAILS STRUCTURAL S0.0 REVISION TABLE OF CONTENTS PRIOR DEVELOPMENT PERMITS S1.0 GENERAL PLANS DETAILS PREVIOUS PERMITS: C80-07-197, T81-11-170, H88-10-174, CIVIL AD95-791, AD96-021, GP97-4-4, PP00-025, AD13-522 SP21-032 C0 COVER SHEET C1 NORTH ARROW C1.1 DOOR IDENTIFICATION C2 C2.1 CONTROL POINT C3 DETAILS LANDSCAPE L1.1 **IRRIGATION PLAN ABBREVIATIONS IRRIGATION DETAILS** L1.2 L1.3 DETAILS ONCRETE GYPSUM GYP PLANTING PLAN L2.1 H.B. HOSE BIB ISH FLOOR I.D. **INSIDE DIAMETER** L2.2 TREE MITIGATION PLAN URAL IN. INCH L2.3 PLANTING DETAILS INFORMATION INFO. INSUL INSULATION LAV. LAVATORY ELECTRICAL MAXIMUM MAX. E-1 ELECTRICAL GENERAL MTL. METAL MFR. MANUFACTURER E-2 ELECTRICAL SITE PLAN M.H. MAN HOLE E-3 MIN. MINIMUM E-4 MISC MISCELLANEOUS (N) NEW E-5 SINGLE LINE DIAGRAM BLDG #1 JOINT NOT APPLICABLE N/A E-6 SINGLE LINE DIAGRAM BLDG #3 NOT IN CONTRACT N.I.C. E-7 NOT TO SCALE GENERATOR DETAILS N.T.S. ON CENTER 0.C. _____E-8 SWITCHBOARD DETAIL - BLDG#1 O.D. OUTSIDE DIAMETER E-9 SWITCHBOARD DETAIL - BLDG#3 OFCI OWNER FURNISHED ICE CONTRACTOR INSTALLED ON OPP. OPPOSITE PAV. PAVING P.D.F. POWDER DRIVEN FASTENER ASTER FINISH PLATE PL. PAPER TOWEL DISPENSER P.T.D. SINK RAD. RADIUS REF. REFRIGERATOR ER ROOM RM. R.D. ROOF DRAIN FOR OFFICIAL USE ONLY REQ. REQUIRED REFLECTED CEILING PLAN R.C.P. RVL. REVEAL RAIN WATER LEADER R.W.L SEE ARCHITECURAL DRAWINGS S.A.D. S.C. SOLID CORE SOAP DISPENSER S.D. SEC. SECTION SHT. SQUARE FOOT N JOINT SIM SHEET SIMILAR S.M.S. SHEET METAL SCREW SPEC. SPECIFICATION STD. STANDARD STL. STEEL STRUCT. STRUCTURAL T.C. TOP OF CURB TEL TELEPHONE AIN T.O.P. TOP OF PARAPET ON TOP OF PAVEMENT T.P. IGUISHER T.P.D. **TOILET PAPER DISPENSER** ANT T.W. TOP OF WALL WOOD SCREW TYP TYPICAL UNLESS OTHERWISE NOTED U.O.N. DOR V.I.F. VERIFY IN FIELD ECTION W/ WITH WATER CLOSET W.C. WD. WOOD W/O WITHOUT W.P. WATERPROOF ED IRON WATER RESISTANT W.R. ALL BOARD WEATHER STRIPPING W.S..

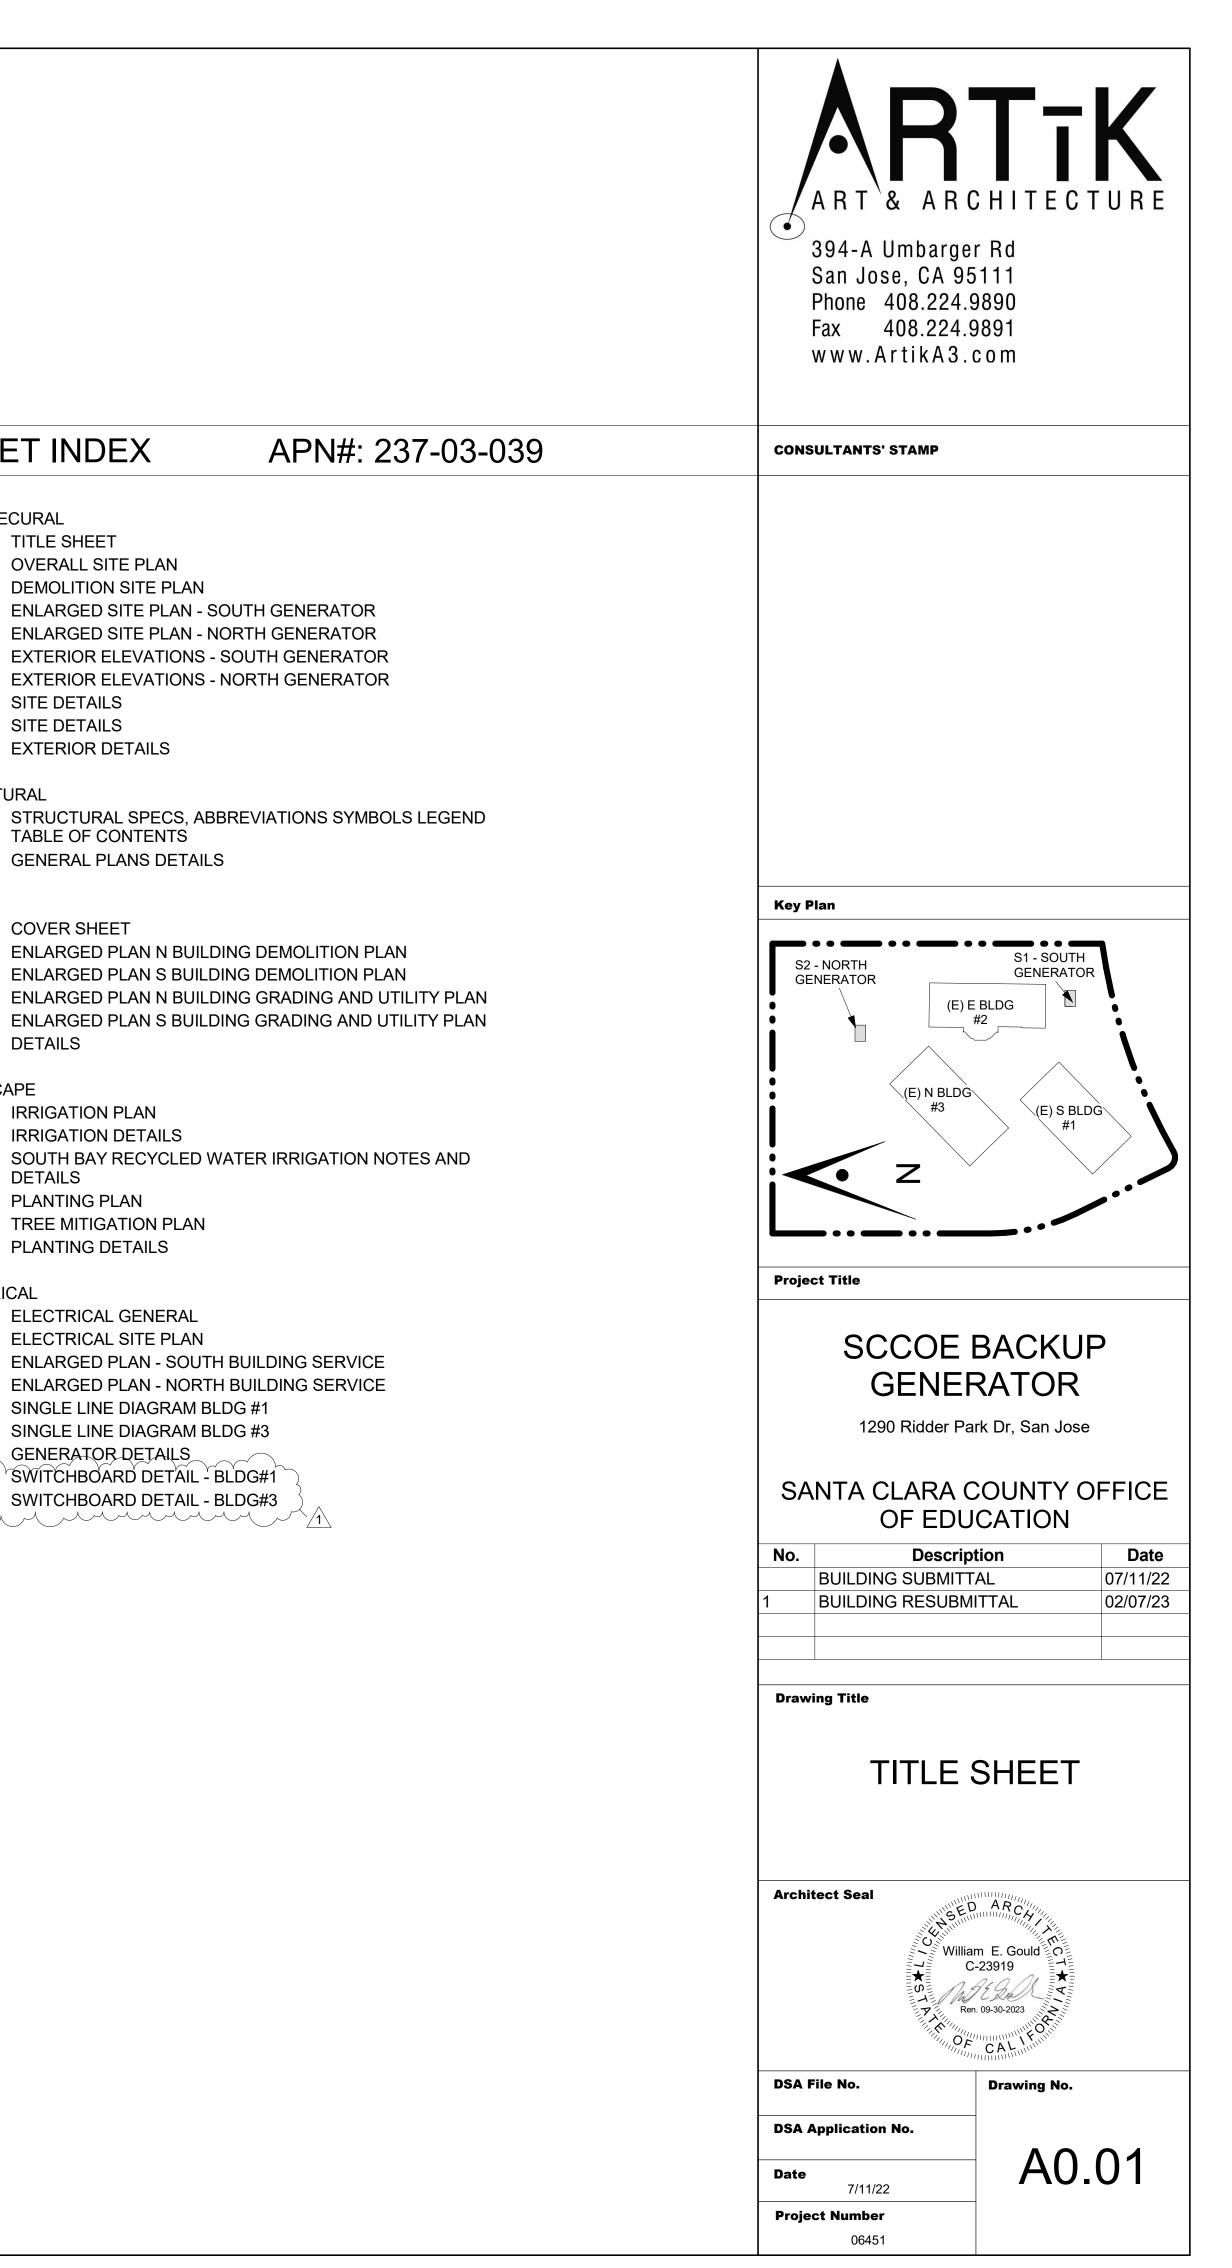

Plot Date 3/4/2023 4:32:13 PM

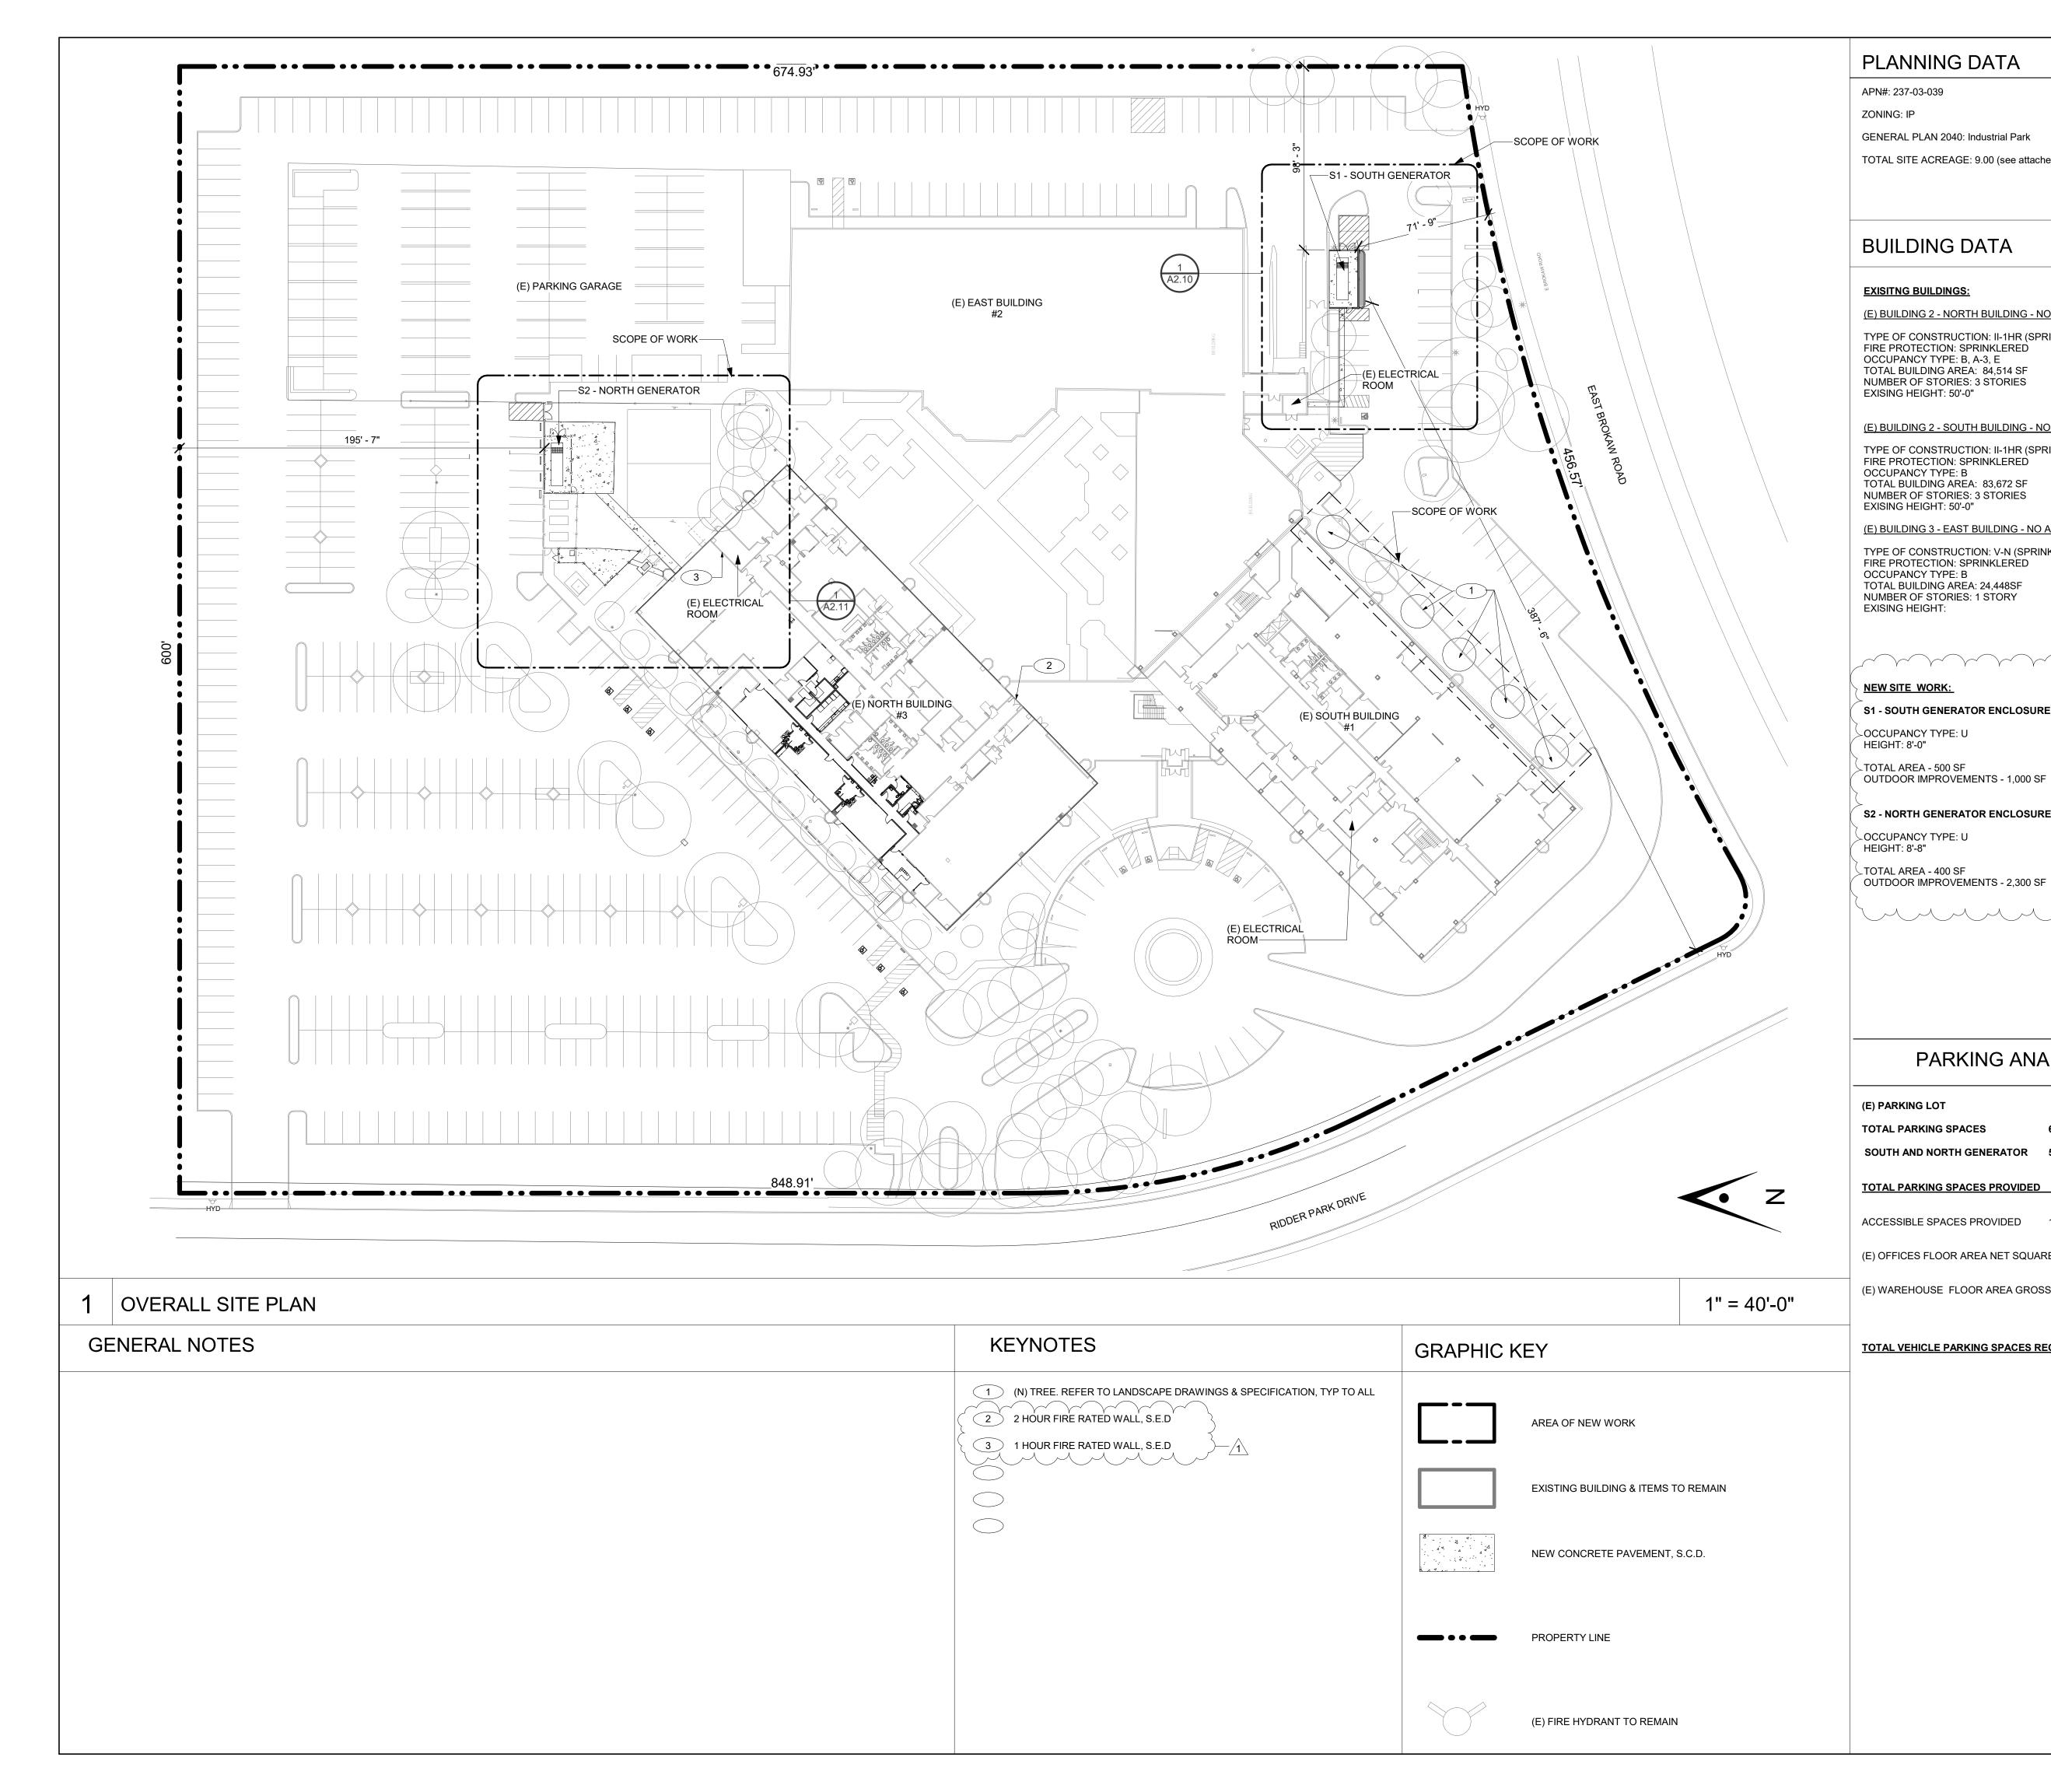

PLANNING DATA

APN#: 237-03-039 ZONING: IP GENERAL PLAN 2040: Industrial Park

TOTAL SITE ACREAGE: 9.00 (see attached Assessor's map)

BUILDING DATA

EXISITNG BUILDINGS:

(E) BUILDING 2 - NORTH BUILDING - NO ADDED AREA OR CHANGE OF OCCUPANCY TYPE OF CONSTRUCTION: II-1HR (SPRINKLERED) FIRE PROTECTION: SPRINKLERED OCCUPANCY TYPE: B, A-3, E TOTAL BUILDING AREA: 84,514 SF NUMBER OF STORIES: 3 STORIES EXISING HEIGHT: 50'-0"

(E) BUILDING 2 - SOUTH BUILDING - NO ADDED AREA OR CHANGE OF OCCUPANCY TYPE OF CONSTRUCTION: II-1HR (SPRINKLERED) FIRE PROTECTION: SPRINKLERED OCCUPANCY TYPE: B TOTAL BUILDING AREA: 83,672 SF NUMBER OF STORIES: 3 STORIES EXISING HEIGHT: 50'-0"

(E) BUILDING 3 - EAST BUILDING - NO ADDED AREA OR CHANGE OF OCCUPANCY

TYPE OF CONSTRUCTION: V-N (SPRINKLERED) FIRE PROTECTION: SPRINKLERED OCCUPANCY TYPE: B TOTAL BUILDING AREA: 24,448SF NUMBER OF STORIES: 1 STORY EXISING HEIGHT:

NEW SITE WORK:

S1 - SOUTH GENERATOR ENCLOSURE


SOCCUPANCY TYPE: U HEIGHT: 8'-0" TOTAL AREA - 500 SF

S2 - NORTH GENERATOR ENCLOSURE HEIGHT: 8'-8"

→TOTAL AREA - 400 SF OUTDOOR IMPROVEMENTS - 2,300 SF

PARKING ANALYSIS

(E) PARKING LOT TOTAL PARKING SPACES 647 PARKING SPACES SOUTH AND NORTH GENERATOR 5 PARKING SPACES REMOVED
 TOTAL PARKING SPACES PROVIDED
 642 PARKING SPACES
 ACCESSIBLE SPACES PROVIDED 13 (9 (E) ACCESSIBLE; 4(E) ACCESSIBLE VAN (E) OFFICES FLOOR AREA NET SQUARE FOOTAGE 173,278 SF 590 PARKING SPACES REQUIRED (E) WAREHOUSE FLOOR AREA GROSS SQUARE FOOTAGE 23,850 SF 5 PARKING SPACES REQUIRED TOTAL VEHICLE PARKING SPACES REQUIRED 595 PARKING SPACES

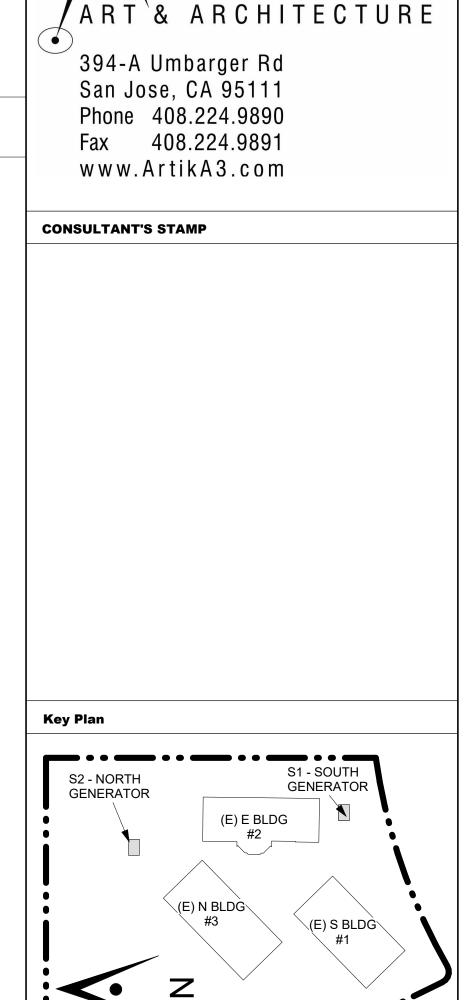

Project Title


SCCOE BACKUP GENERATOR


1290 Ridder Park Dr, San Jose

SANTA CLARA COUNTY OFFICE OF EDUCATION

No.	Description	Date
	BUILDING SUBMITTAL	07/11/22
1	BUILDING RESUBMITTAL	02/07/23


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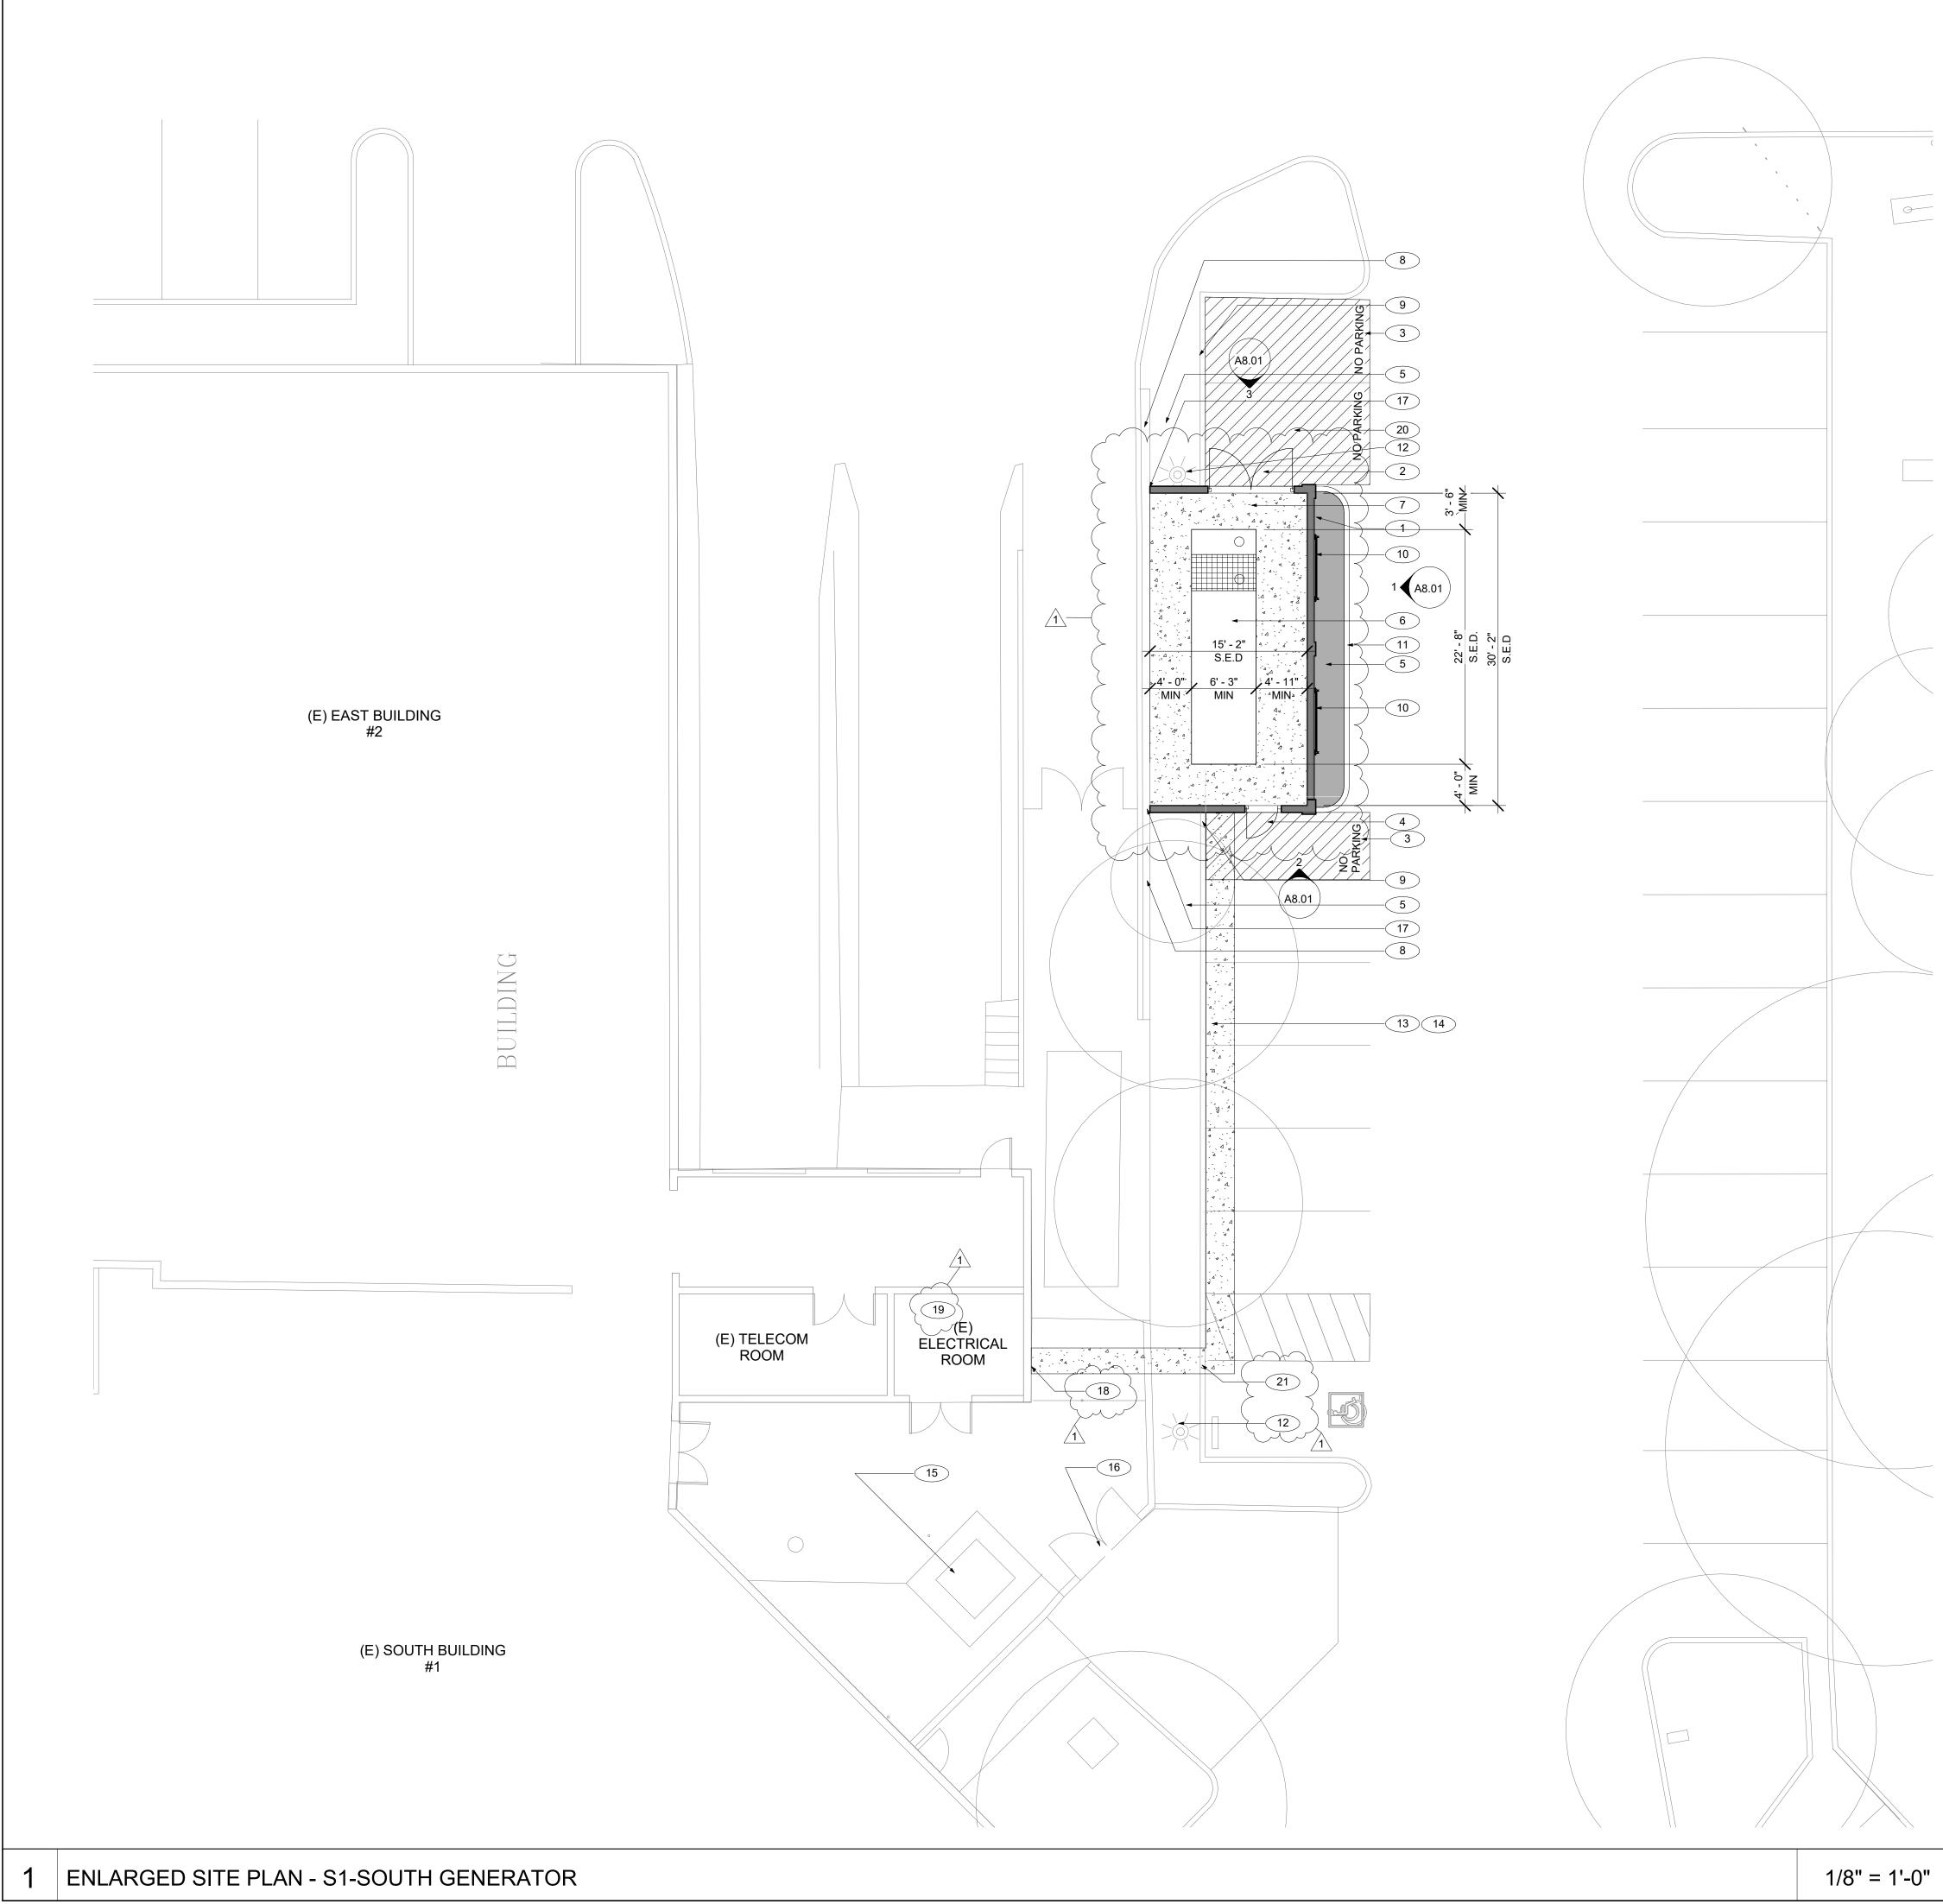


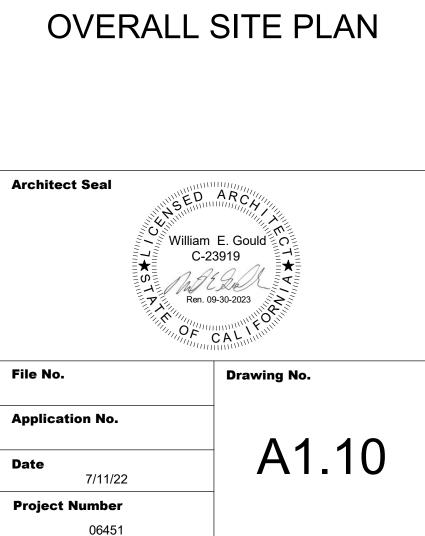	HYD	
(E) EAST BUILDING		
	EAST END	AROKAN ROAD
(E) NORTH BUILDING #3		
	(E) SOUTH BUILDING #1	
848.91'	RIDDER PARK DRIVE	
	RINE	
KEYNOTES		
1 DEMO (E) PLANTERS AMD GARDEN AND PREPARE TO RECEIVE NEW CONCRETE PAVING/ C NEW PLAN FOR MORE INFORMATION.	ONCRETE PAD. SEE	

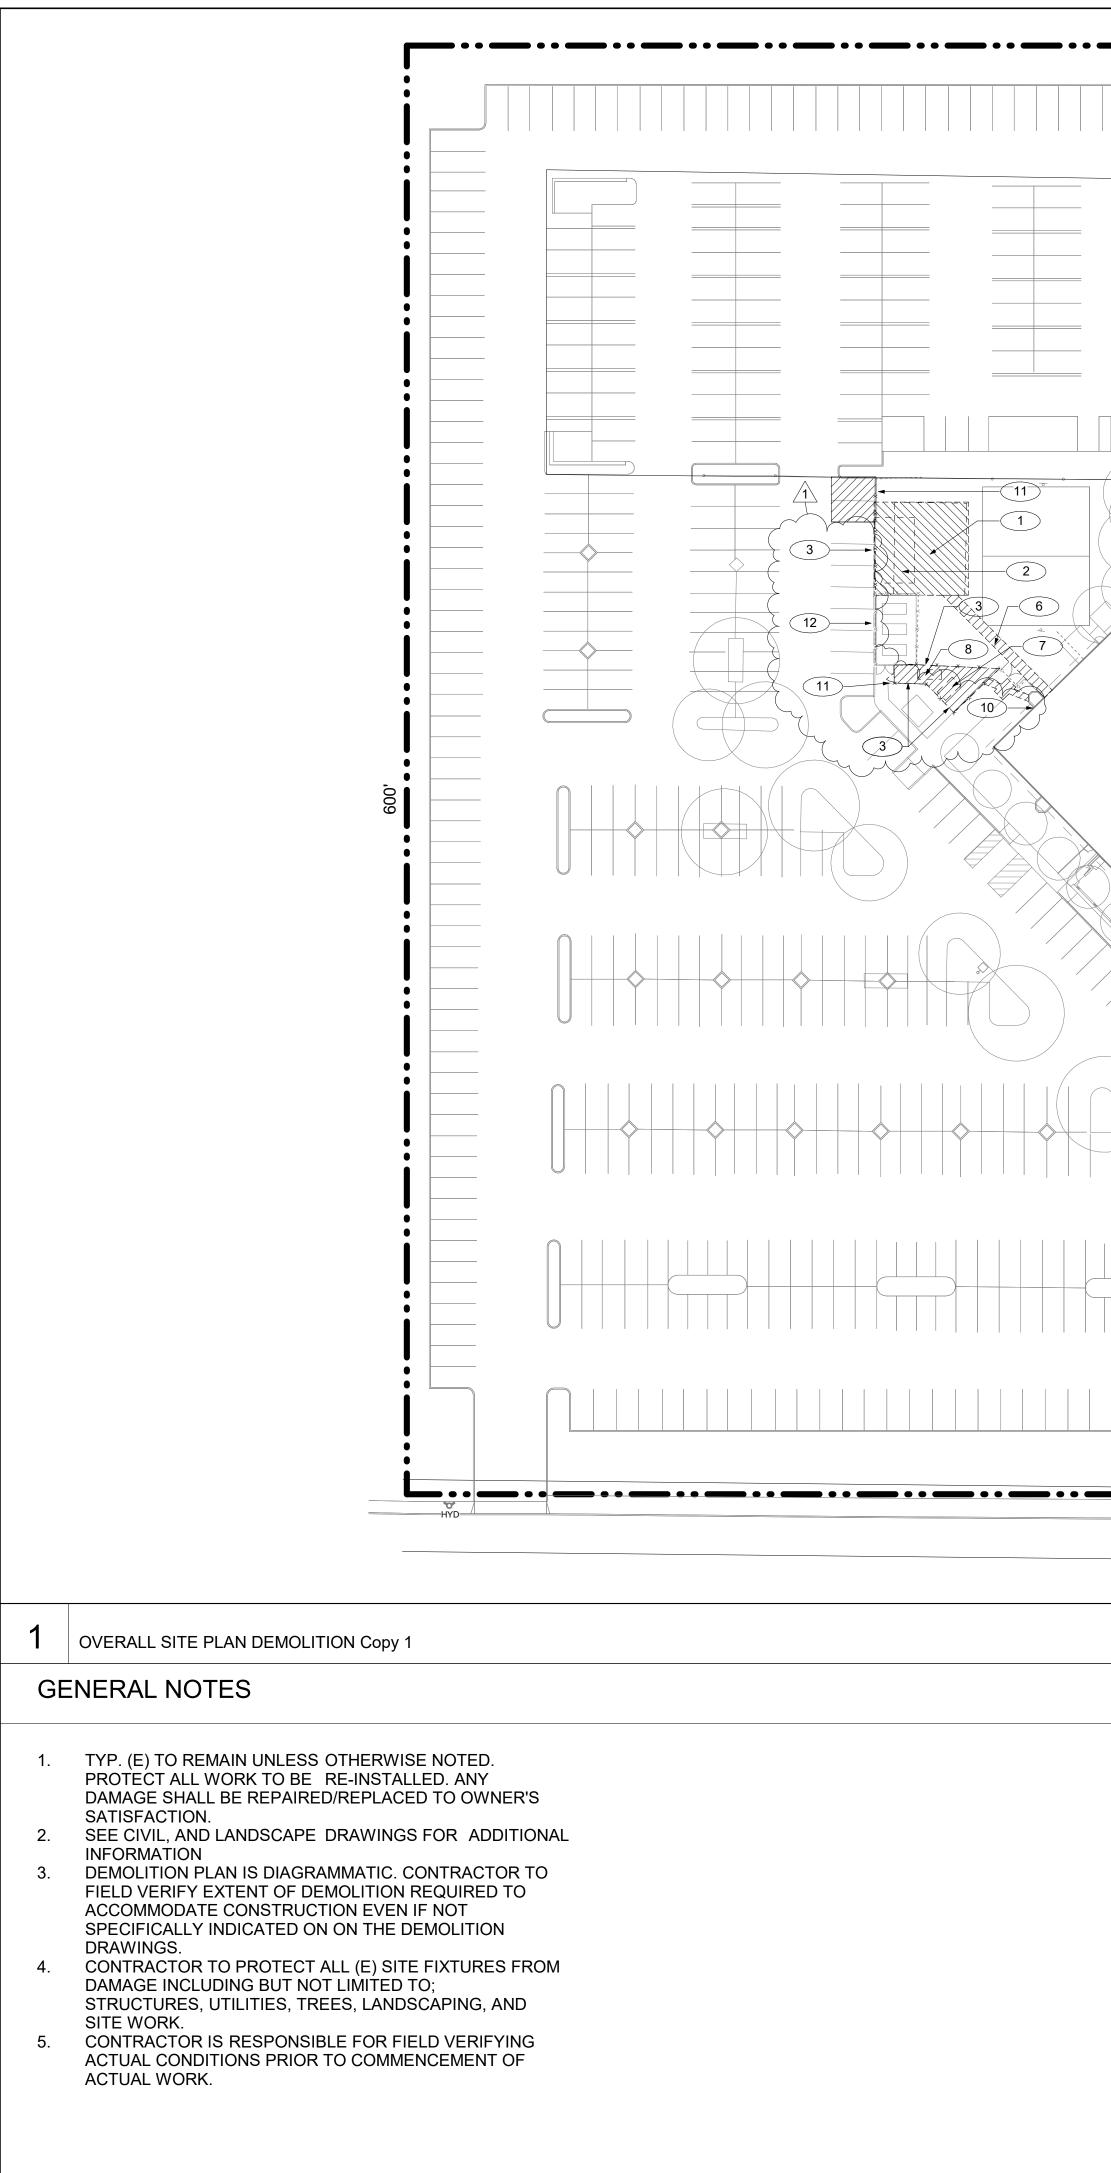		DEMO (E) PLANTERS AMD GARDEN AND PREPARE TO RECEIVE NEW CONCRETE PAVING/ CONCRETE PAD. SEE NEW PLAN FOR MORE INFORMATION.
	2	DEMO (E) CONCRETE/ AC TO RECEIVE (N) CONCRETE PAD. SEE NEW PLAN FOR MORE INFORMATION.
	3	DEMO (E) FENCE. SEE NEW PLAN FOR MORE INFORMATION
	4	DEMO (E) TREE. S.L.D. FOR MORE INFORMATION
	5	DEMO (E) CURB AND PLANTING
	6	(N) TRENCH, SAWCUT (E) AC FOR ELECTRICAL CONDUITS. SEE CIVIL AND ELECTRICAL DRAWINGS.
	7	DEMO (E) GENERATOR, CONCRETE PAD AND ALL RELATED ACCESSORIES, S.E.D. PREPARE TO RECEIVE NEW CONCRETE PAVING
1	8	DEMO (E) FUEL TANK, CONCRETE PAD AND ALL RELATED ACCESSORIES, S.E.D. PREPARE TO RECEIVE NEW
	9	(E) LIGHT POLE TO REMAIN. PROTECT DURING CONSTRUCTION. SEE NEW PLAN AND ELECTRICAL DRAWINGS
>	10	DEMO (E) ELECTRICAL COUNDUIT AND EQUIPMENT FOR DEMOLISHED GENERATOR.
7		DEMO (E) GATE. SEE NEW PLANS FOR MORE INFORMATION.
٦		(E) CHAINLINK FENCE TO REMAIN AND BE PROTECTED DURING CONSTRUCTION



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- CONTRACTOR TO FIELD VERIFY EXISTING CONDITIONS PRIOR TO COMMENCEMENT OF WORK. EXISTING OVERALL SITE FEATURES ARE SHOWN FOR REFERENCE ONLY. EXACT SIZES AND LOCATIONS MAY NOT BE TRUE TO
- SCALE. CONTRACTOR TO PROTECT ALL (E) SITE FEATURES TO REMAIN FROM DAMAGE INCLUDING BUT NOT LIMITED TO, STRUCTURES, UTILITIES, TREES, LANDSCAPING
- AND SITE WORK.
- REFER TO TEMPORARY TREE AND PLANT PROTECTION SPECIFICATION AND DETAIL A/L4.3 FOR ALL EXISTING-TO-REMAIN TREES, S.L.D CONTRACTOR SHALL COORDINATE ROUGH GRADING AND FINE GRADING TO ENSURE EXISTING SUITABLE TOPSOIL IS REMOVED, STOCKPILED AND REINSTALLED INTO ALL PROPOSED LANDSCAPE AREAS PER LANDSCAPE SPECIFICATION. IN THE EVENT THERE IS NOT ENOUGH EXISTING TOPSOIL, OR NO PLACE TO STOCKPILE TOPSOIL, CONTRACTOR SHALL IMPORT AND INSTALL TOPSOIL PER LANDSCAPE SPECIFICATION, S.L.D

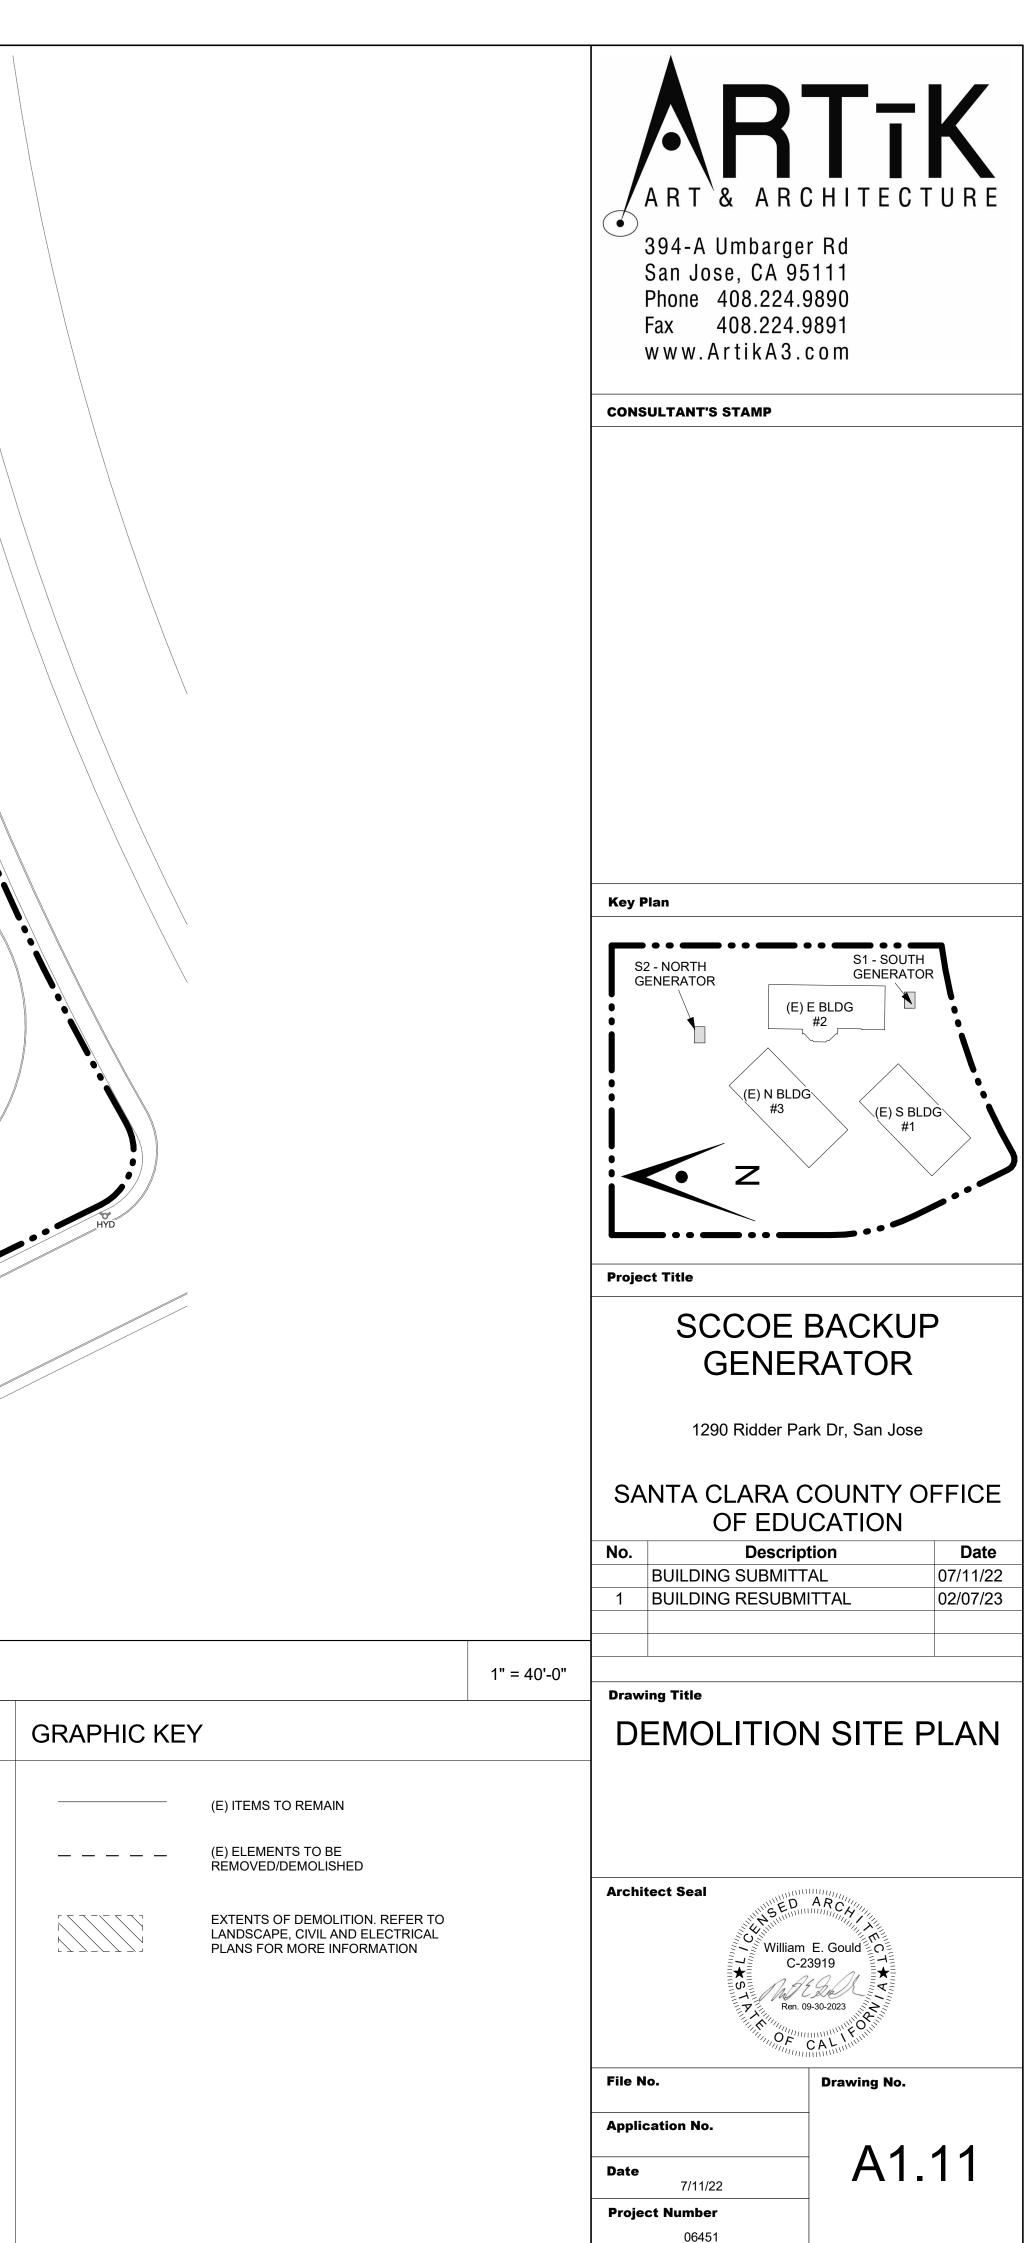

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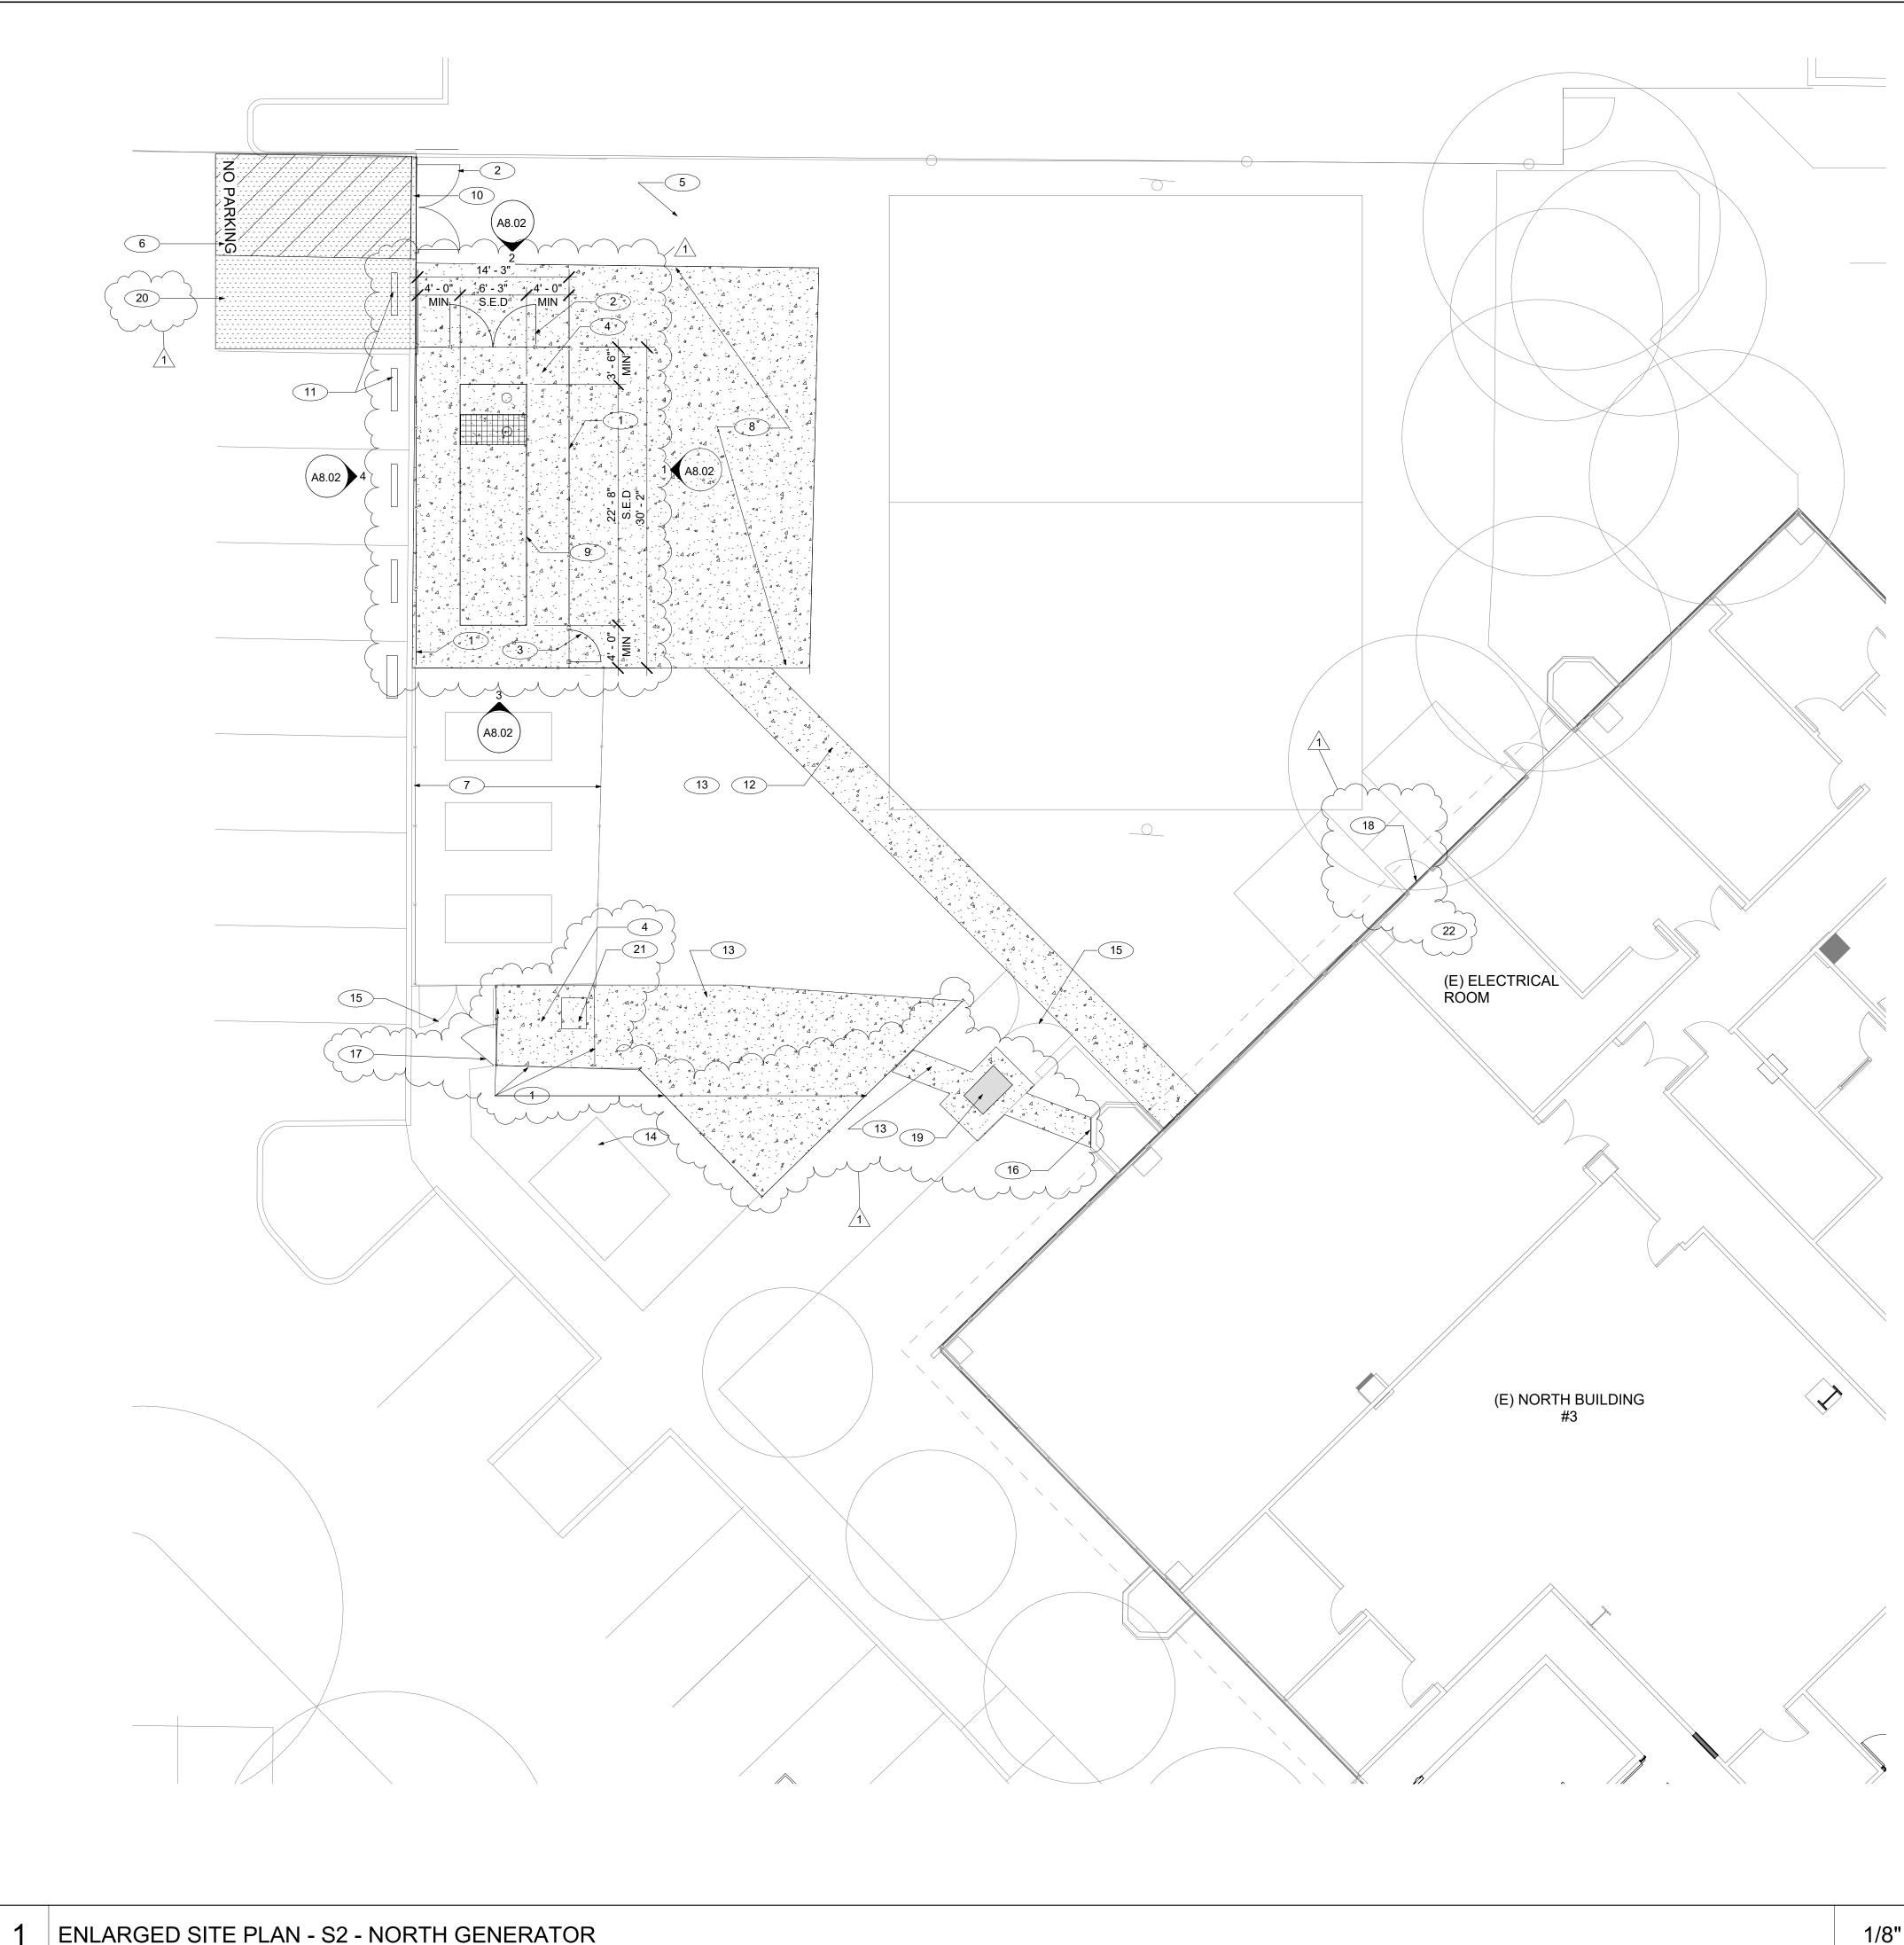
CONSULTANT'S STAMP

KEYNOTES

(N) 10' HIGH STUCCO WALL, SEE A12.32 2 8' WIDE X 7' HIGH ORNAMENTAL GATE. SEE DETAIL 2/A12.11 3 NO PARKING IN 12" HIGH LETTERS AND NEW STRIPING 4 3' WIDE X 7' HIGH ORNAMENTAL GATE. SEE DETAIL 2/A12.11 5 (N) PLANTER, REFER TO LANDSCAPE DRAWINGS & SPECIFICATION, TYP TO ALL 6 GENERATOR, S.E.D 7 NEW CONCRETE PAD, S.S.D. Key Plan (E) 8' TALL WALL. PROTECT DURING CONSTRUCTION 9 (E) CURB. PROTECT DURING CONSTRUTION S1 - SOUTH S2 - NORTH GENERATOR GENERATOR (N) MODULAR PLANT TRELLIS. BASIS OF DESIGN VERTIGREEN BY TOURNERSOL (E) E BLDG #2 (N) CURB RAMP. S.C.D. (E) LIGHT POLE TO REMAIN. PROTECT DURING CONSTRUCTION. SEE NEW PLAN AND ELECTRICAL DRAWINGS ∖(E) N BLDĠ∖ **#**3 ∖(E) S BLDĠ∖ 13 PATCH AND REPAIR PAVING TO MATCH EXISTING ADJACENT. S.C.D #1 (N) AC PAVING, TYP. S.C.D. Ζ (E) PG&E TRANSFORMER TO REMAIN. PROTECT DURING CONSTRUCTION. (E) GATE TO REMAIN AND BE PROTECTED DURING CONSTRUCTION 17 SEE STRUCTURAL DRAWINGS FOR WALL ATTACHMENT **Project Title** 18 PATCH AND REPAIR (E) WALL TO MATCH ADJACENT EXISTING CEMENT PLASTER, SEE A12.32. SCCOE BACKUP (N) ELECTRICAL EQUIPMENT. S.E.D GENERATOR 20 (N) AC OVERLAY, S.C.D. 21 S.S.D. FOR ELEC CONDUITS FOUNDATION PENETRATION DETAIL. 1290 Ridder Park Dr, San Jose SANTA CLARA COUNTY OFFICE OF EDUCATION Description Date No. **BUILDING SUBMITTAL** 07/11/22 1 BUILDING RESUBMITTAL 02/07/23 **Drawing Title** ENLARGED SITE PLAN -**GRAPHIC KEY** SOUTH GENERATOR EXISTING ITEMS NEW ITEMS **Architect Seal** NEW CONSTRUCTION WALL William E. Gould C-23919 Ren. 09-30-2023 NEW CONCRETE PAVEMENT, S.C.D. CAL File No. Drawing No. **Application No.** A2.10 Date 7/11/22

Project Number

06451



- . CONTRACTOR TO FIELD VERIFY EXISTING CONDITIONS PRIOR TO COMMENCEMENT OF WORK. EXISTING OVERALL SITE FEATURES ARE SHOWN FOR REFERENCE ONLY. EXACT SIZES AND LOCATIONS MAY NOT BE TRUE TO SCALE.
- 2. CONTRACTOR TO PROTECT ALL (E) SITE FEATURES TO REMAIN FROM DAMAGE INCLUDING BUT NOT LIMITED TO, STRUCTURES, UTILITIES, TREES, LANDSCAPING AND SITE WORK.
- AND SITE WORK.
 REFER TO TEMPORARY TREE AND PLANT PROTECTION SPECIFICATION AND DETAIL A/L4.3 FOR ALL EXISTING-TO-REMAIN TREES, S.L.D
- 4. CONTRACTOR SHALL COORDINATE ROUGH GRADING AND FINE GRADING TO ENSURE EXISTING SUITABLE TOPSOIL IS REMOVED, STOCKPILED AND REINSTALLED INTO ALL PROPOSED LANDSCAPE AREAS PER LANDSCAPE SPECIFICATION. IN THE EVENT THERE IS NOT ENOUGH EXISTING TOPSOIL, OR NO PLACE TO STOCKPILE TOPSOIL, CONTRACTOR SHALL IMPORT AND INSTALL TOPSOIL PER LANDSCAPE SPECIFICATION, S.L.D




394-A Umbarger Rd San Jose, CA 95111 Phone 408.224.9890 Fax 408.224.9891 www.ArtikA3.com

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KEYNOTES

(N) 8'-8" TALL GALVANIZED CHANLINK FENCE WITH LIGHT BROWN PRIVACY SLATS, COLOR AND HEIGHT TO MATCH ADJACENT EXISTING.4/A12.12 2 8' WIDE X 8'-8" HIGH GALVANIZED CHANLINK GATE WITH LIGHT BROWN PRIVACY SLATS. COLOR AND HEIGHT TO MATCH EXISITNG. SEE DETAIL 6/A12.12 3 3' WIDE X 8'-8" HIGH GALVANIZED CHANLINK GATE WITH LIGHT BROWN PRIVACY SLATS. SEE DETAIL 5/A12.12 4 NEW CONCRETE PAD, S.S.D. (E) CONCRETE PAVING TO REMAIN, TYP. 6 NO PARKING IN 12" HIGH LETTERS AND NEW STRIPING (E) CHAINLINK FENCE TO REMAIN AND BE PROTECTED DURING CONSTRUCTION 8 (N) CONCRETE PAVING 9 GENERATOR, S.E.D (N) FLUSH CURB. S.C.D. (N) WHEEL STOP, TYP. S.C.D. (12) PATCH AND REPAIR PAVING TO MATCH EXISTING ADJACENT. S.C.D (N) CONCRETE PAVING, TYP.S.C.D (E) PG&E TRANSFORMER TO REMAIN. PROTECT DURING CONSTRUCTION. (E) GATE TO REMAIN AND BE PROTECTED DURING CONSTRUCTION 16 PATCH THE WALLS AFTER REMOVING OF (E) PANELS AND CONDUITS, MATCH CEMENT PLASTER WITH EXISTING, SEE A12.32. 4' WIDE X 8'-8" HIGH GALVANIZED CHANLINK GATE WITH LIGHT BROWN PRIVACY SLATS. SEE DETAIL 5/A12:12 (17) REMOVE & RE-INSTALL (E) STOREFRONT FOR ELECTRICAL EQUIPMENT INSTALLATION. COORDINATE WITH ELECTRICAL DRAWINGS. 18 (19) (N) PULL BOX, SEE CIVIL AND ELECTRICAL DWG. 20 (N) AC OVERLAY TO FLUSH WITH CURB. S.C.D Λ^- (N) MTS AND CONCRETE PAD. S.E.D. & S.S.D. (N) ELECTRICAL EQUIPMENT. S.E.D

Key Plan

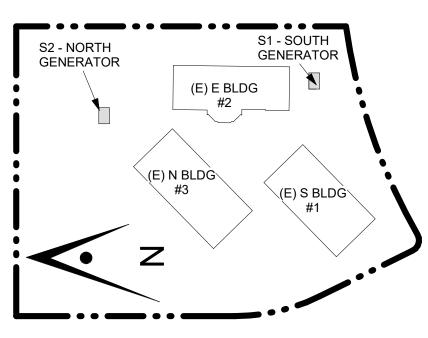


Project Title


SCCOE BACKUP GENERATOR


1290 Ridder Park Dr, San Jose

SANTA CLARA COUNTY OFFICE OF EDUCATION

NO.	Description	Date
	BUILDING SUBMITTAL	07/11/22
1	BUILDING RESUBMITTAL	02/07/23

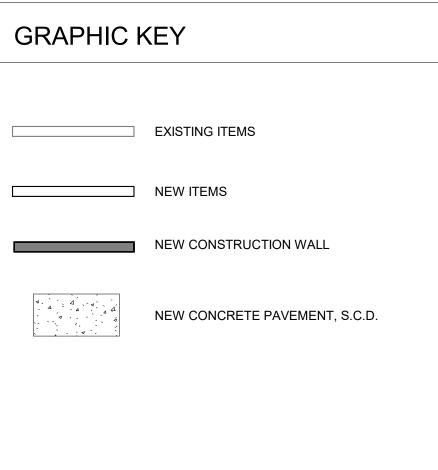

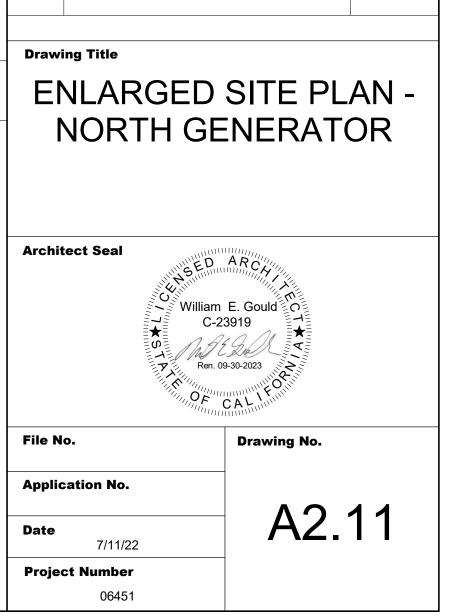

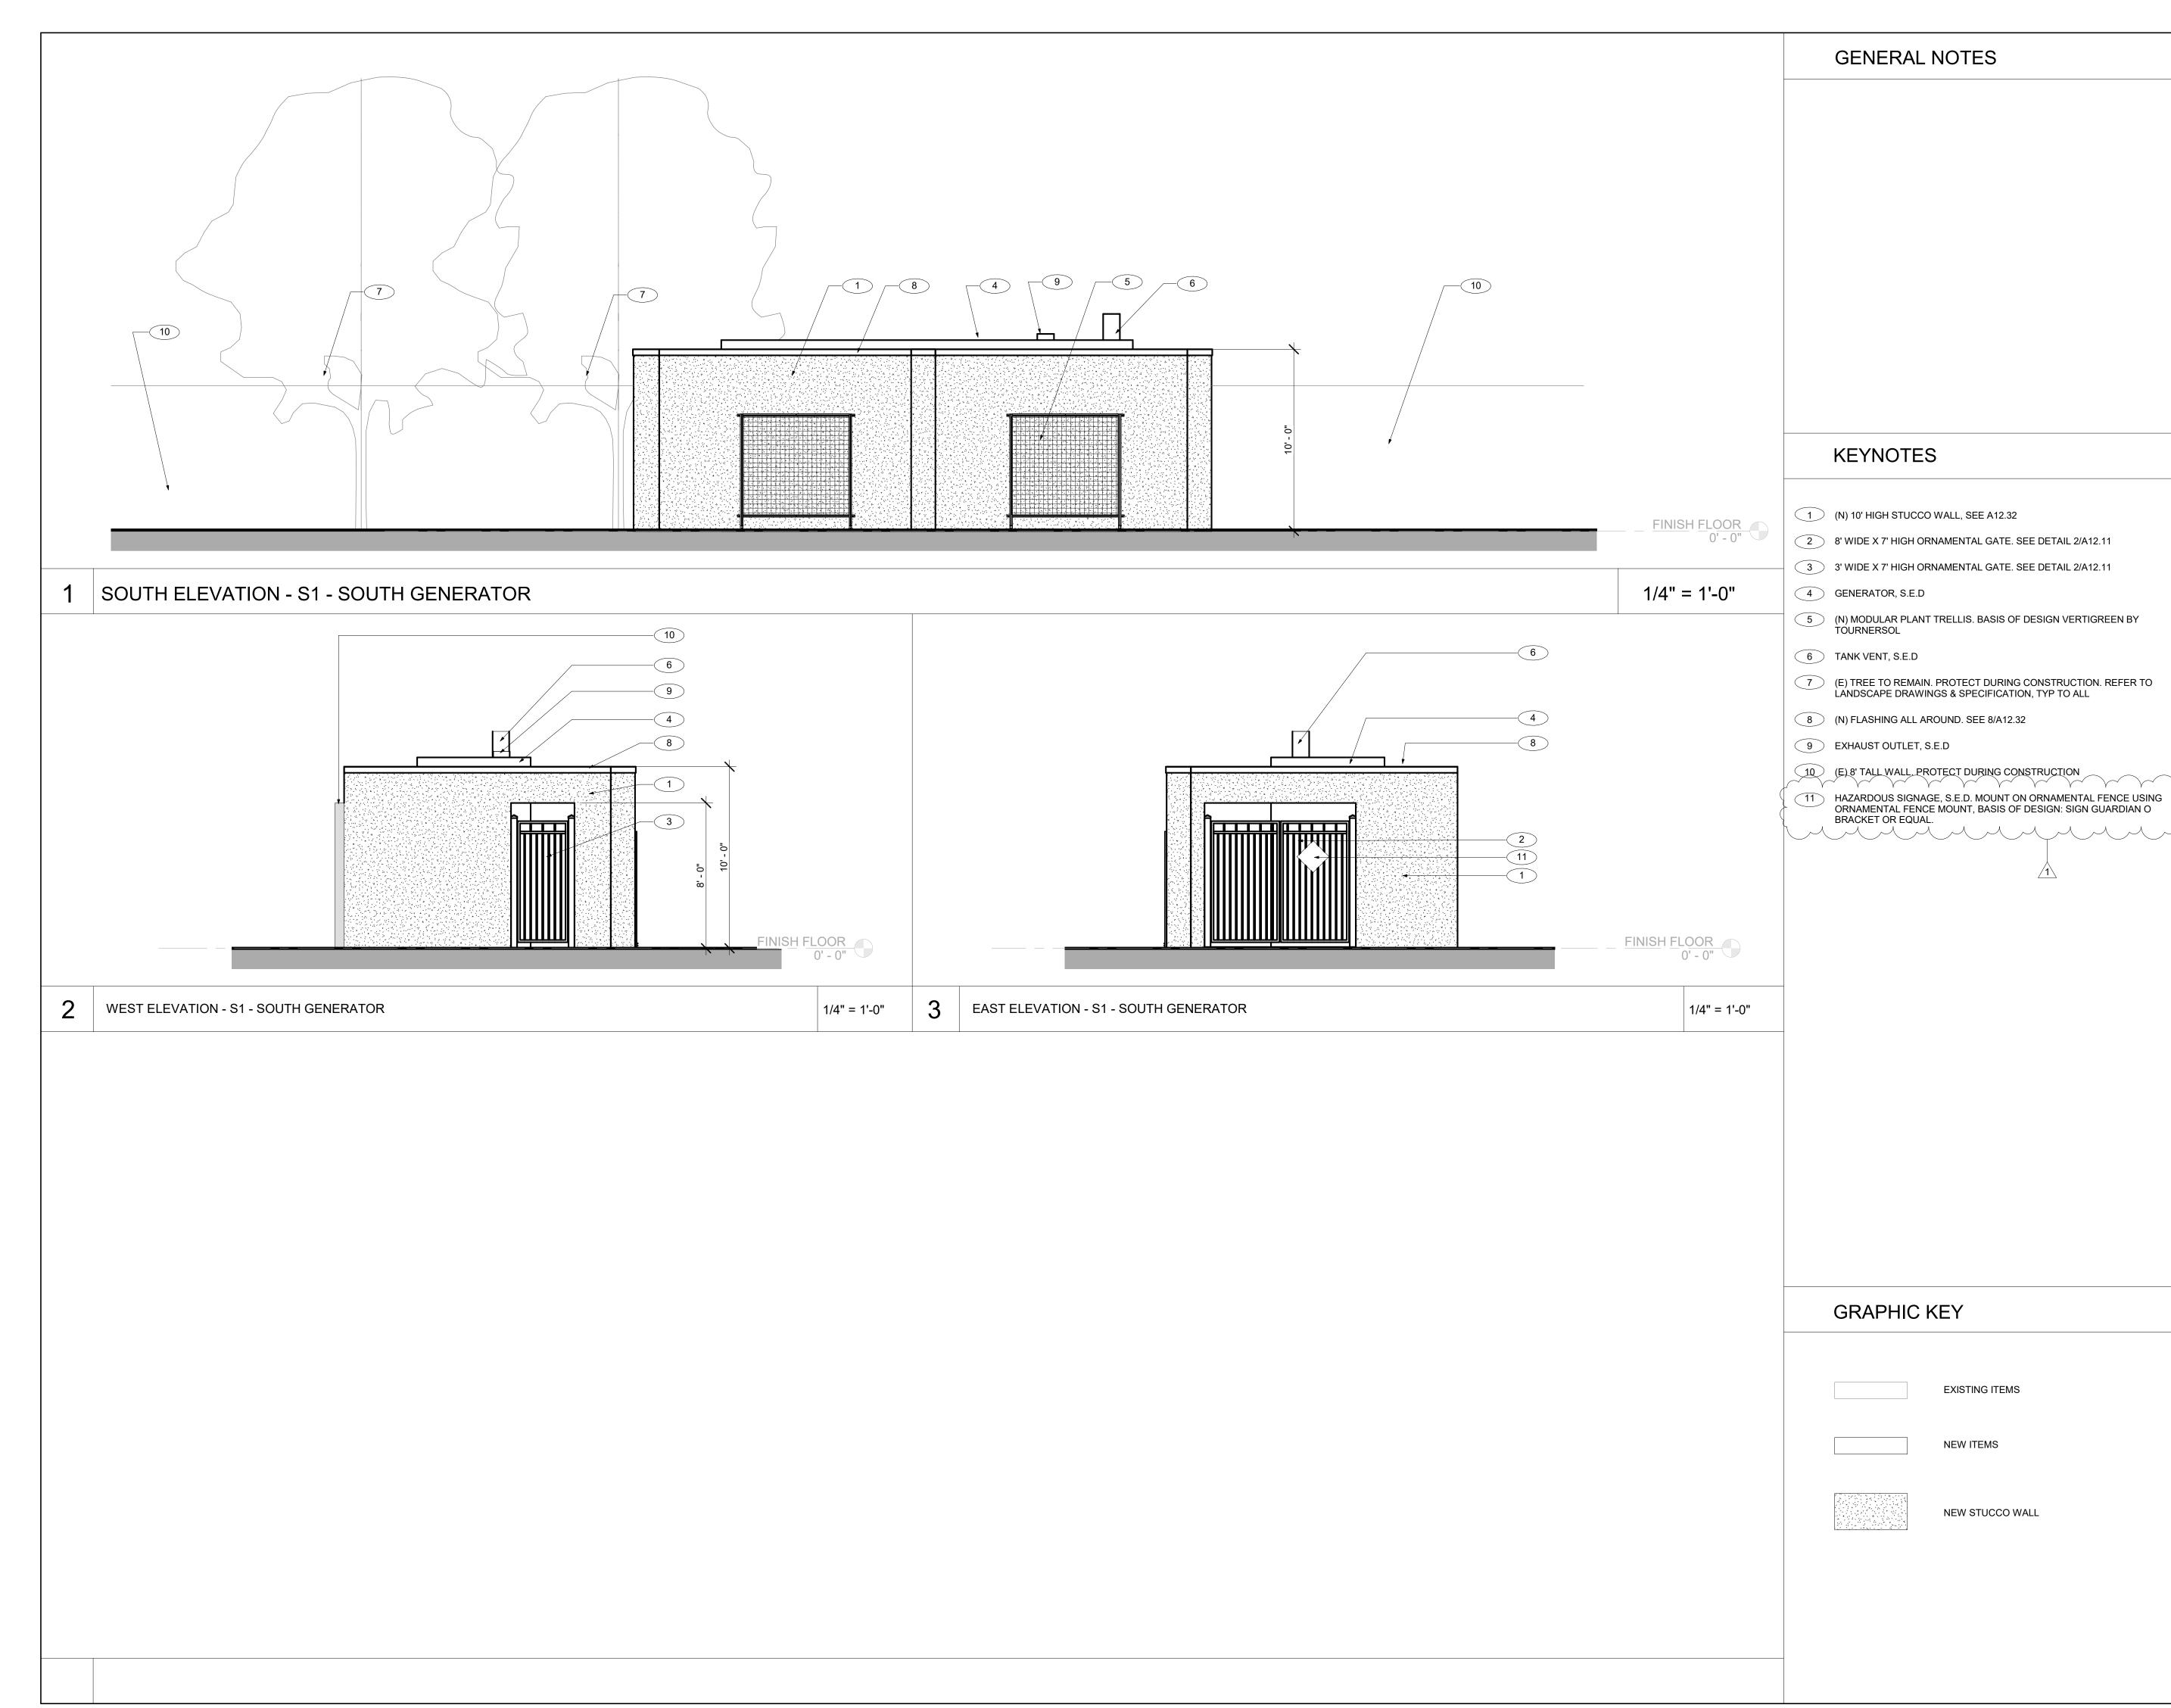



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CONSULTANT'S STAMP

Key Plan

____.

S2 - NORTH

GENERATOR

S1 - SOUTH GENERATOR

(E) E BLDG

#2

(E) N BLDG

#3

∕(E) S BLDĠ∖ #1

KEYNOTES


(N) 10' HIGH STUCCO WALL, SEE A12.32 2 8' WIDE X 7' HIGH ORNAMENTAL GATE. SEE DETAIL 2/A12.11 3 3' WIDE X 7' HIGH ORNAMENTAL GATE. SEE DETAIL 2/A12.11 4 GENERATOR, S.E.D 5 (N) MODULAR PLANT TRELLIS. BASIS OF DESIGN VERTIGREEN BY TOURNERSOL 6 TANK VENT, S.E.D (E) TREE TO REMAIN. PROTECT DURING CONSTRUCTION. REFER TO LANDSCAPE DRAWINGS & SPECIFICATION, TYP TO ALL 8 (N) FLASHING ALL AROUND. SEE 8/A12.32 9 EXHAUST OUTLET, S.E.D 10 (E) 8' TALL WALL, PROTECT DURING CONSTRUCTION



GRAPHIC KEY


NEW ITEMS

EXISTING ITEMS

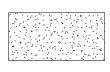

NEW STUCCO WALL

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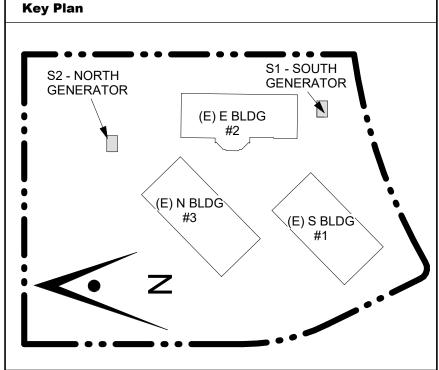

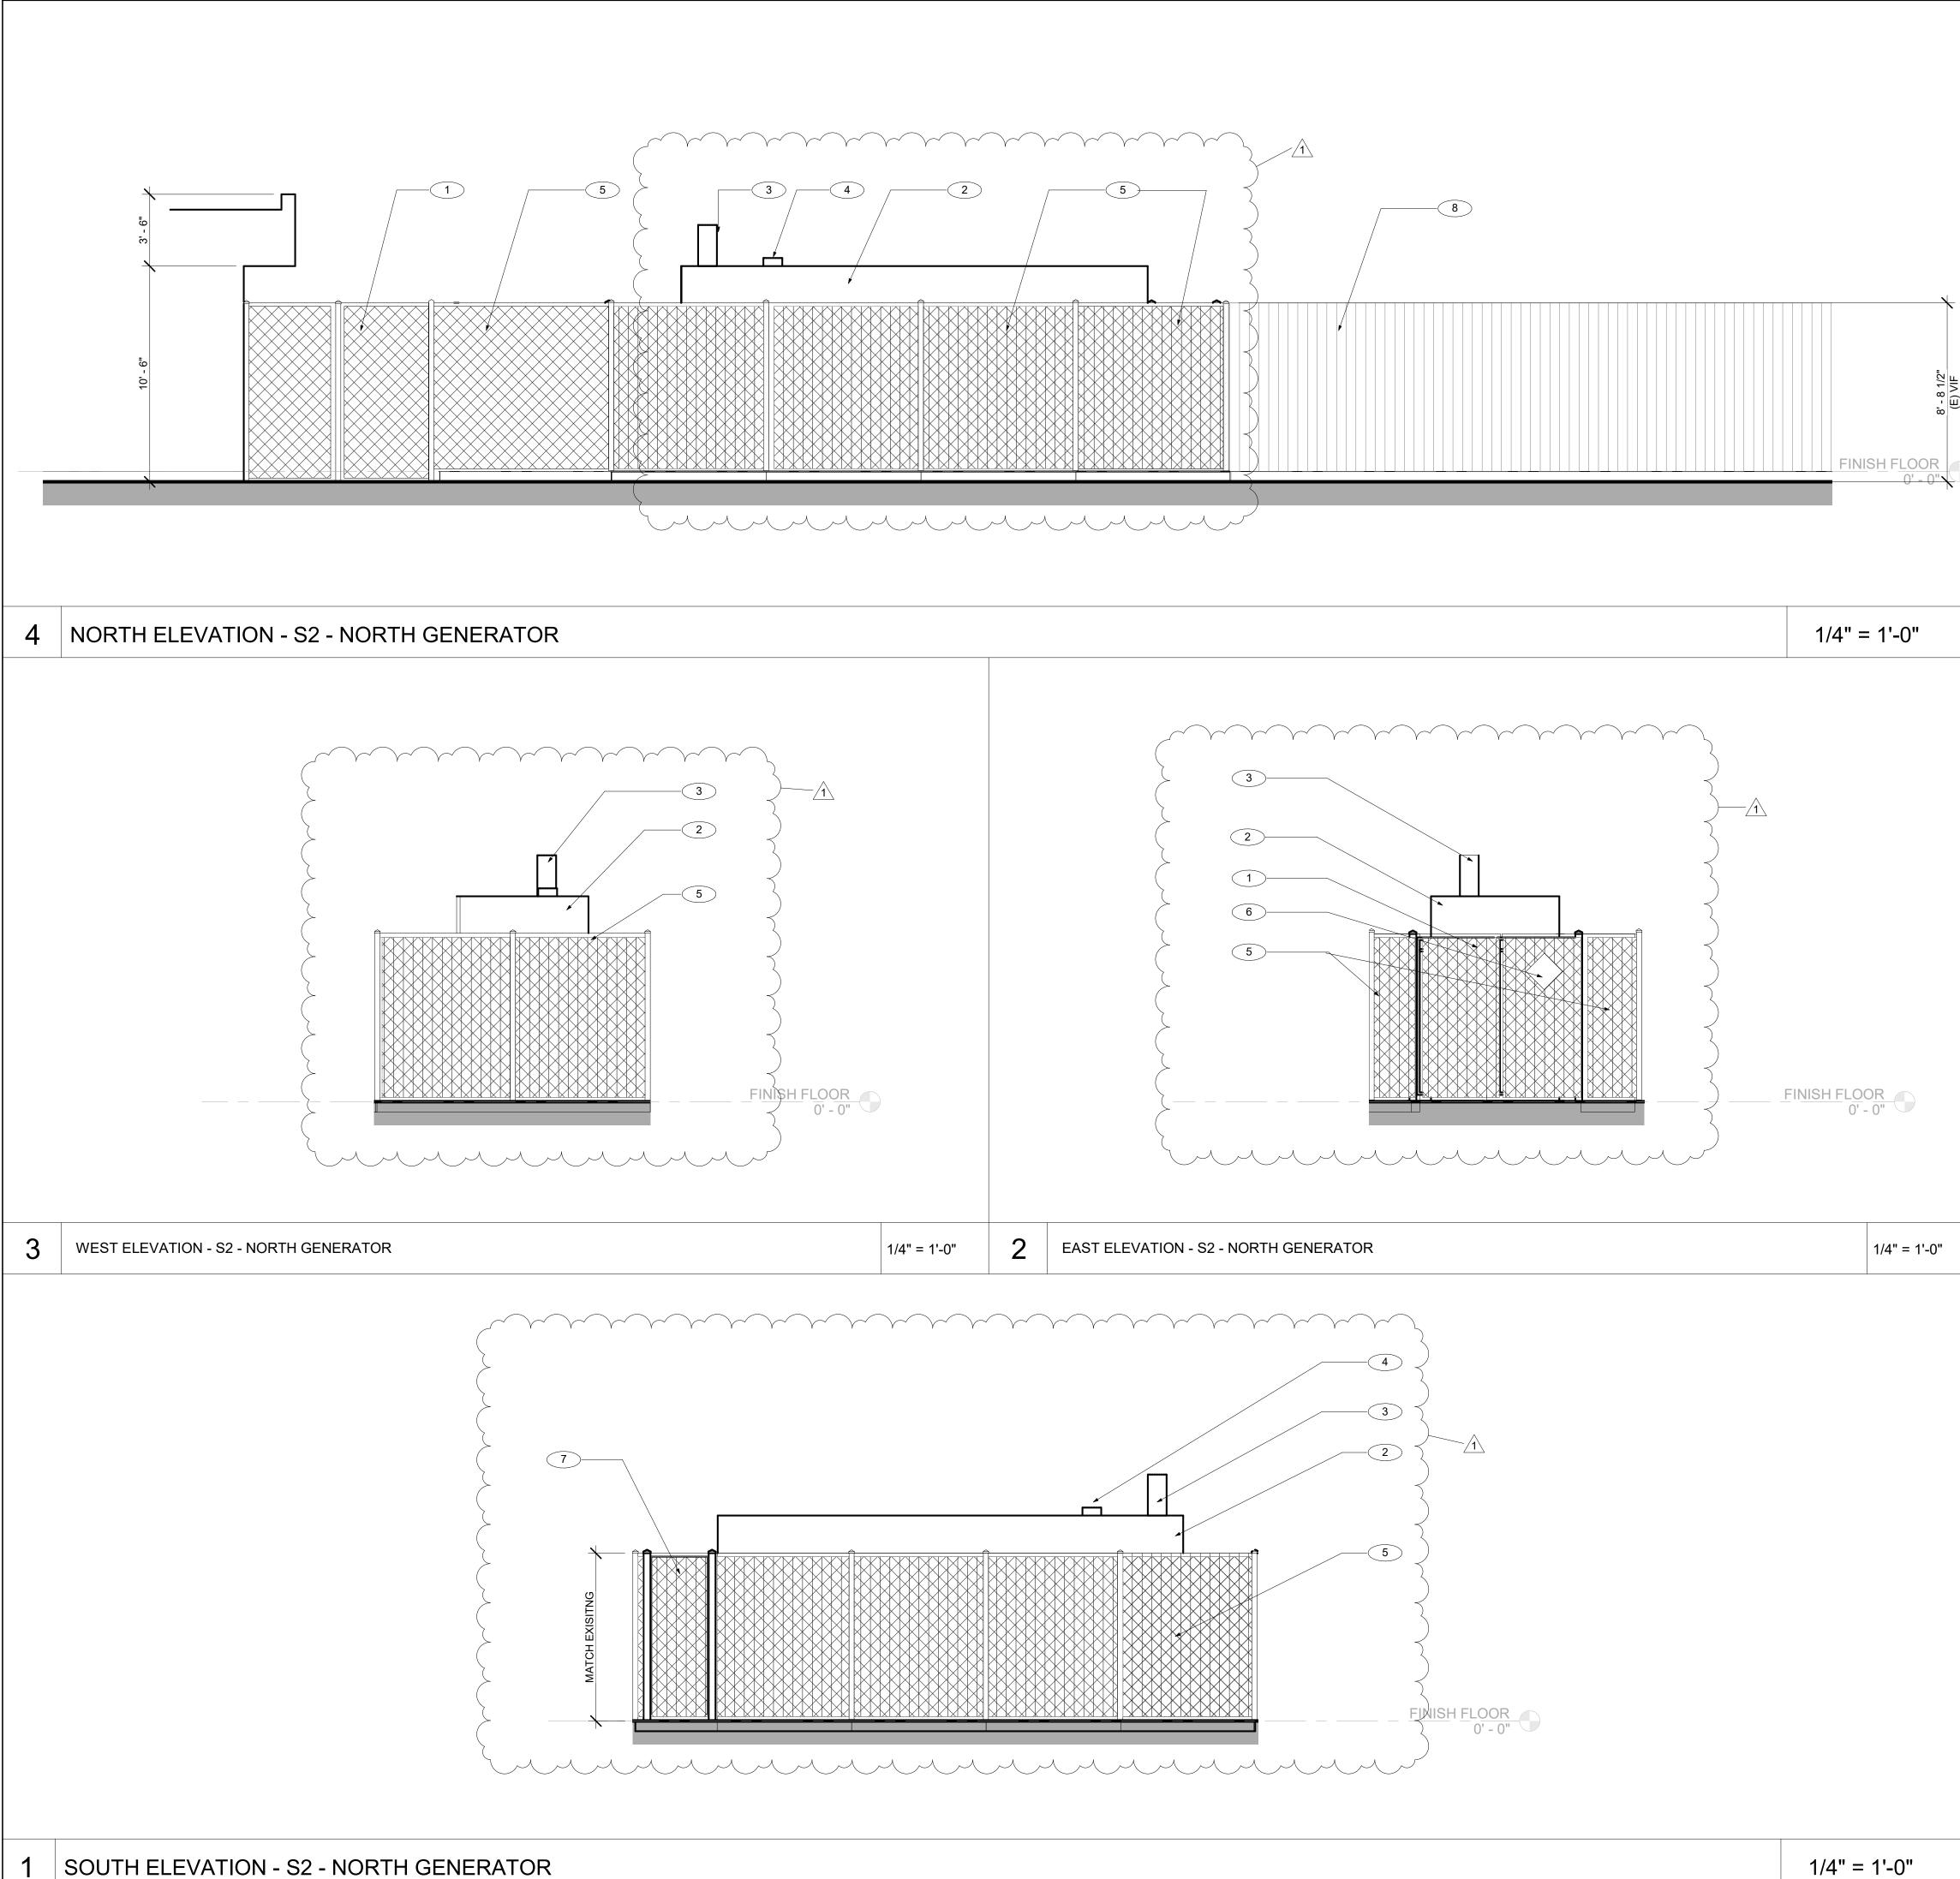
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CONSULTANT'S STAMP

KEYNOTES

- 1 8' WIDE X 8'-8" HIGH GALVANIZED CHANLINK GATE WITH LIGHT BROWN PRIVACY SLATS. COLOR AND HEIGHT TO MATCH EXISITNG. SEE DETAIL 6/A12.12
- 2 GENERATOR, S.E.D
- 3 TANK VENT, S.E.D
- 4 EXHAUST OUTLET, S.E.D
- 5 (N) 8'-8" TALL GALVANIZED CHANLINK FENCE WITH LIGHT BROWN PRIVACY SLATS, COLOR AND HEIGHT TO MATCH ADJACENT EXISTING.4/A12.12
- $\searrow \frown \bigtriangledown$ 6 HAZARDOUS SIGNAGE, S.E.D. MOUNT ON ORNAMENTAL FENCE USING ORNAMENTAL FENCE MOUNT, BASIS OF DESIGN: SIGN GUARDIAN O BRACKET OR EQUAL
- 7 3' WIDE X 8'-8" HIGH GALVANIZED CHANLINK GATE WITH LIGHT BROWN PRIVACY SLATS. SEE DETAIL 5/A12.12
- 8 (E) CHAINLINK FENCE TO REMAIN AND BE PROTECTED DURING CONSTRUCTION



Project Title


SCCOE BACKUP GENERATOR

1290 Ridder Park Dr, San Jose

SANTA CLARA COUNTY OFFICE OF EDUCATION No. Description Date

NO.	Description	Dale
	BUILDING SUBMITTAL	07/11/22
1	BUILDING RESUBMITTAL	02/07/23

Drawing Title

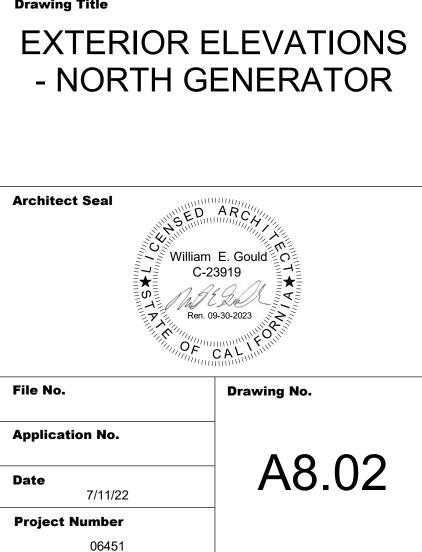

GRAPHIC KEY

EXISTING CHAIN LINK FENCE


EXISTING ITEMS

NEW ITEMS

NEW CHAIN LINK FENCE

NEW CHAIN LINK FENCE WITH PRIVACY SLATS

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-	
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-	
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POST AND CONCRETE FOOTING SCHEDULE

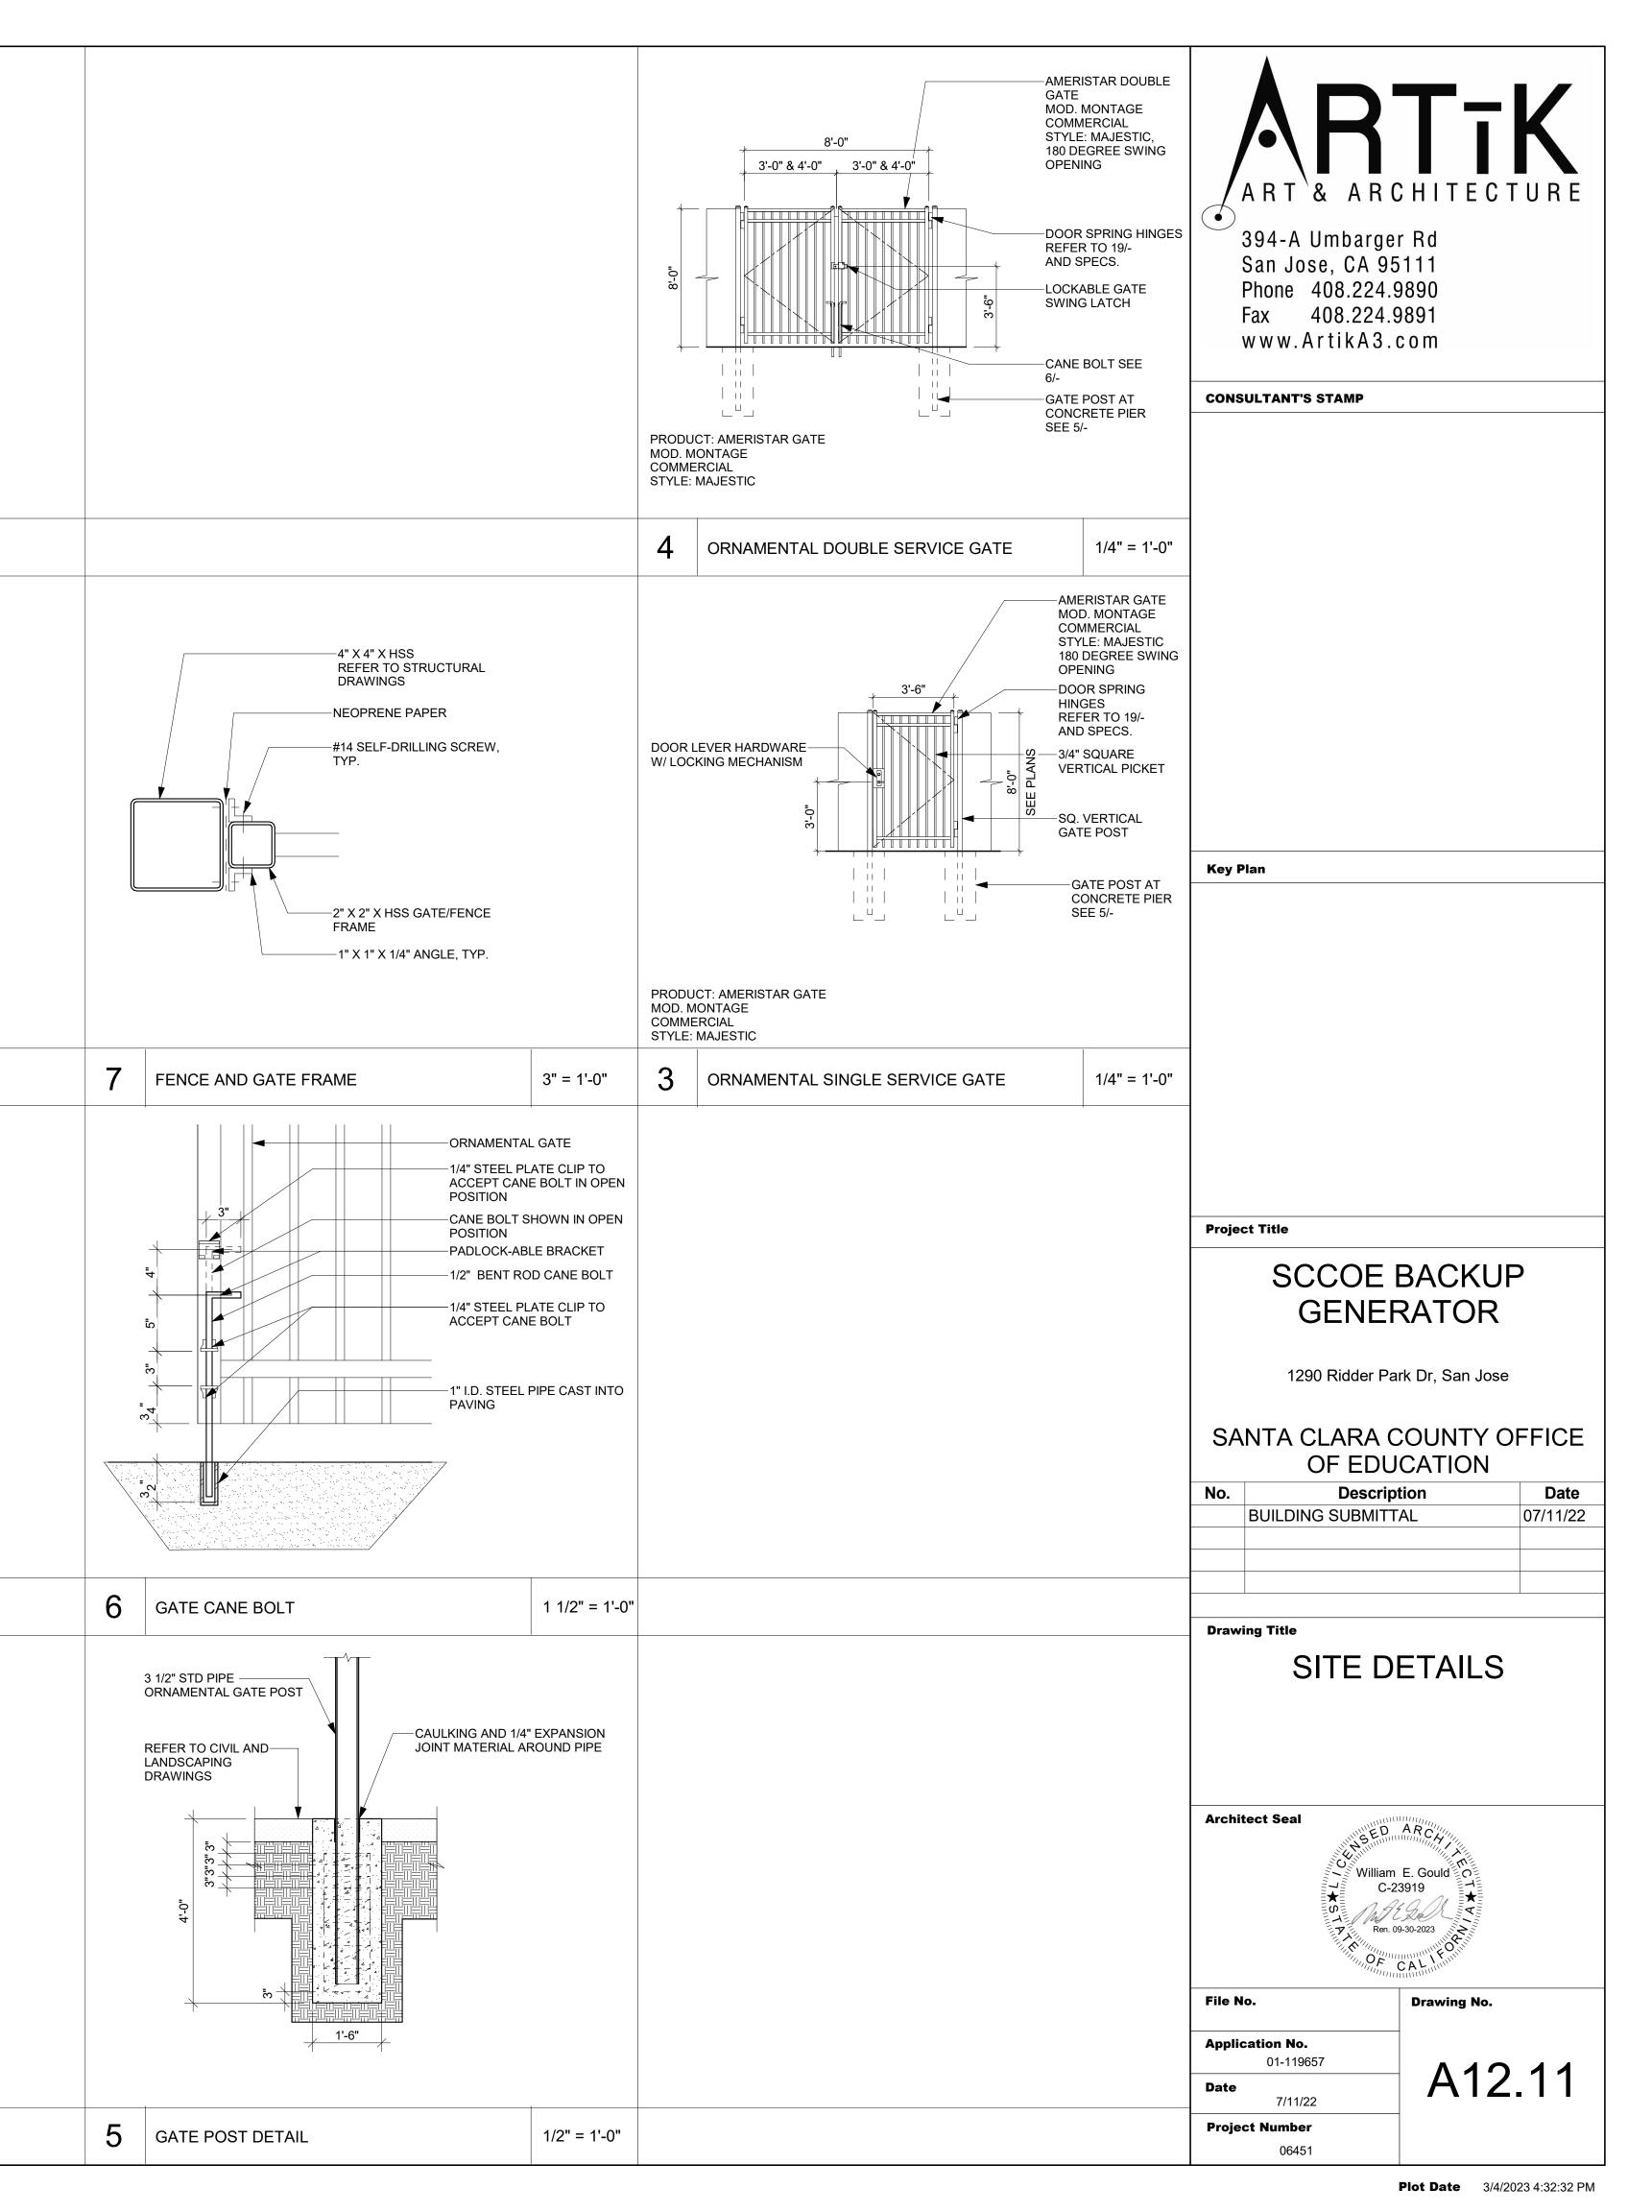
	FENCE PO	OSTS	FENCE/GATE	
FENCE/GATE HEIGHT	LINE POST @10'-0" MAX	END OR CORNER POST	PIER DEPTH	PIER DIAMETER
6'-0" MAXIMUM	3" STD. PIPE	3" STD. PIPE	4'-3"	1'-0"
8'-0" MAXIMUM	3.5" STD. PIPE	3.5" STD. PIPE	5'-0"	1'-6"
10'-0" MAXIMUM	5" STD. PIPE	5" STD. PIPE	5'-6"	1'-6"
12'-0" MAXIMUM	5" STD. PIPE	5" STD. PIPE	6'-0"	1'-6"

FENCE SPECIFICATIONS:

1- GALVANIZED: ALL COMPONENTS OF FENCING INCLUDING BUT NOT LIMITED TO FENCE FABRIC MESH, POSTS, RAILS, RODS, TIES, BRACES, WIRES, AND HARDWARE TO BE GALVANIZED FINISH. 2- FABRIC SIZE: 2" MESH, 9 GAUGE WIRE SIZE PLUS.

3- POSTS AND RAILS: HEAVY INDUSTRIAL STRENGTH, ROUND STEEL PIPE, SCHEDULE 40


8 CHAIN LINK FENCE SCHEDULE 3/8" = 1'-0"

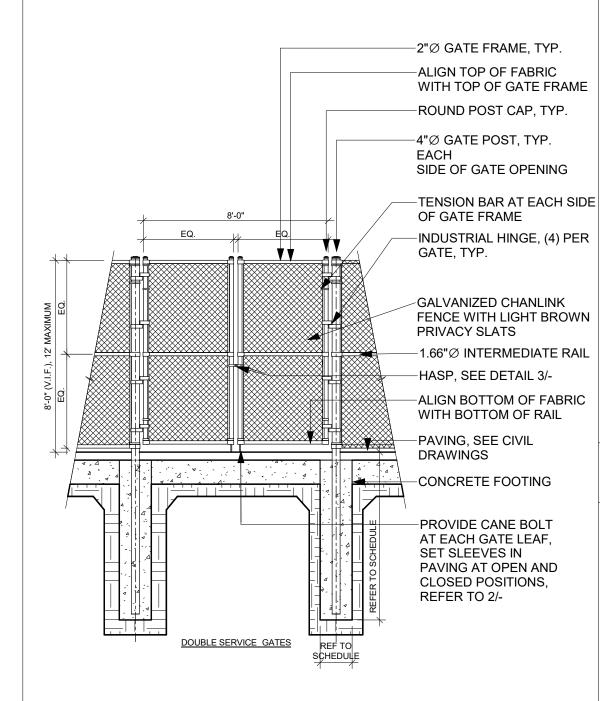

FENCE SPECIFICATIONS: 1- GALVANIZED: ALL COMPONENTS OF FENCING INCLUDING BUT NOT LIMITED TO


FENCE FABRIC MESH, POSTS, RAILS, RODS, TIES, BRACES, WIRES, AND HARDWARE TO BE GALVANIZED FINISH. 2- FABRIC SIZE: 1" MESH, 9 GAUGE WIRE SIZE PLUS. GALVANIZED WITH LIGHT

BROWN PRIVACY SLATS 3- POSTS AND RAILS: HEAVY INDUSTRIAL STRENGTH, ROUND STEEL PIPE, SCHEDULE 40

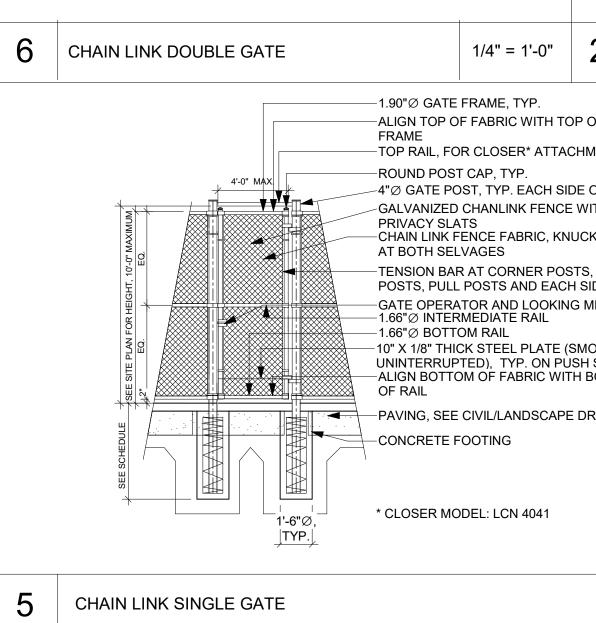


SCHEDULE SEE SITE PLAN	END OR CORNER 10-0" O.C., MAXIMUM	SEE SCHEDUL TENSION BAR POSTS, END P POSTS AND EA GATE FRAME GALVANIZED O FENCE WITH L PRIVACY SLAT INTERMEDIATE POST SIZE, SE TRUSS ROD AI LINE POST PEI	FRAME CAP, TYP. TCH POST SIZE, E AT CORNER OSTS, PULL ACH SIDE OF CHANLINK IGHT BROWN S E RAIL, MATCH E SCHEDULE ND FITTINGS R SCHEDULE CIVIL DRAWINGS MATCH POST IEDULE M OF FABRIC I OF RAIL DOTING	ART & ARC 394-AUmbarger San Jose, CA 95 Phone 408.224.9 Fax 408.224.9 www.ArtikA3.0	5111 9890 9891
4	CHAIN LINK FENCE		1/4" = 1'-0"		
+ <u>3'-6"</u> WELD + 3'-0"_		CHAIN LINK GA CHAIN LINK GA LEVERS 1/4" DI TYPICAL LATCH FENCE POST GATE FRAME WELD 1/2" X 1 1/2" X 2 1/4" DIA. STEEL LATCH EACH S TYP. GATE LAT	TE FRAME A. WELDED H " X 1/8" . WELD IDE		
		LEVERS WELD, TYP.		Key Plan	
		WELD TO GATE 3'-0"	E FRAME AT		
		1/2" DIA. HOLE	FOR PADI OCK		
•	1 1/2				
3	GATE HASP		1 1/2" = 1'-0"		
			PLATE CLIP TO NE BOLT IN OPEN		
		CANE BOLT POSITION	SHOWN IN OPEN	Project Title	
	4		OD CANE BOLT	SCCOE I GENEF	BACKUP RATOR
			L PIPE CAST INTO	1290 Ridder Pa	
		_ PAVING	L FIFE CAST INTO	SANTA CLARA C	
				OF EDU No. Descript BUILDING SUBMITT	tion Date
2	GATE CANE BOLT		1 1/2" = 1'-0"		
۲				Drawing Title	
OF GAT				SITE DI	ETAILS
	TE OPENING HT BROWN				
				Architect Seal	ARCHINA International
MECHAI 100TH	NISM				E. Gould O
H SIDE BOTTOM				Ren. 05	9-30-2023
RAWIN				File No.	Drawing No.
	 NOTES: REFER TO DETAIL 4/- FOR NOTES NOT SHO CHAINLINK FABRIC TO BE VINYL COATED REFER TO DETAIL 8/- FOR POST SIZES AND 			Application No.	Liaming No.
	4) PIER DIAMETER: CONSTRAINED = 1'-6" \emptyset , N		NED = 2'-6"Ø	Date 7/11/22	A12.12
		1	/4" = 1'-0"	Project Number 06451	
					Plot Date 3/4/2023 4:32:33 PM

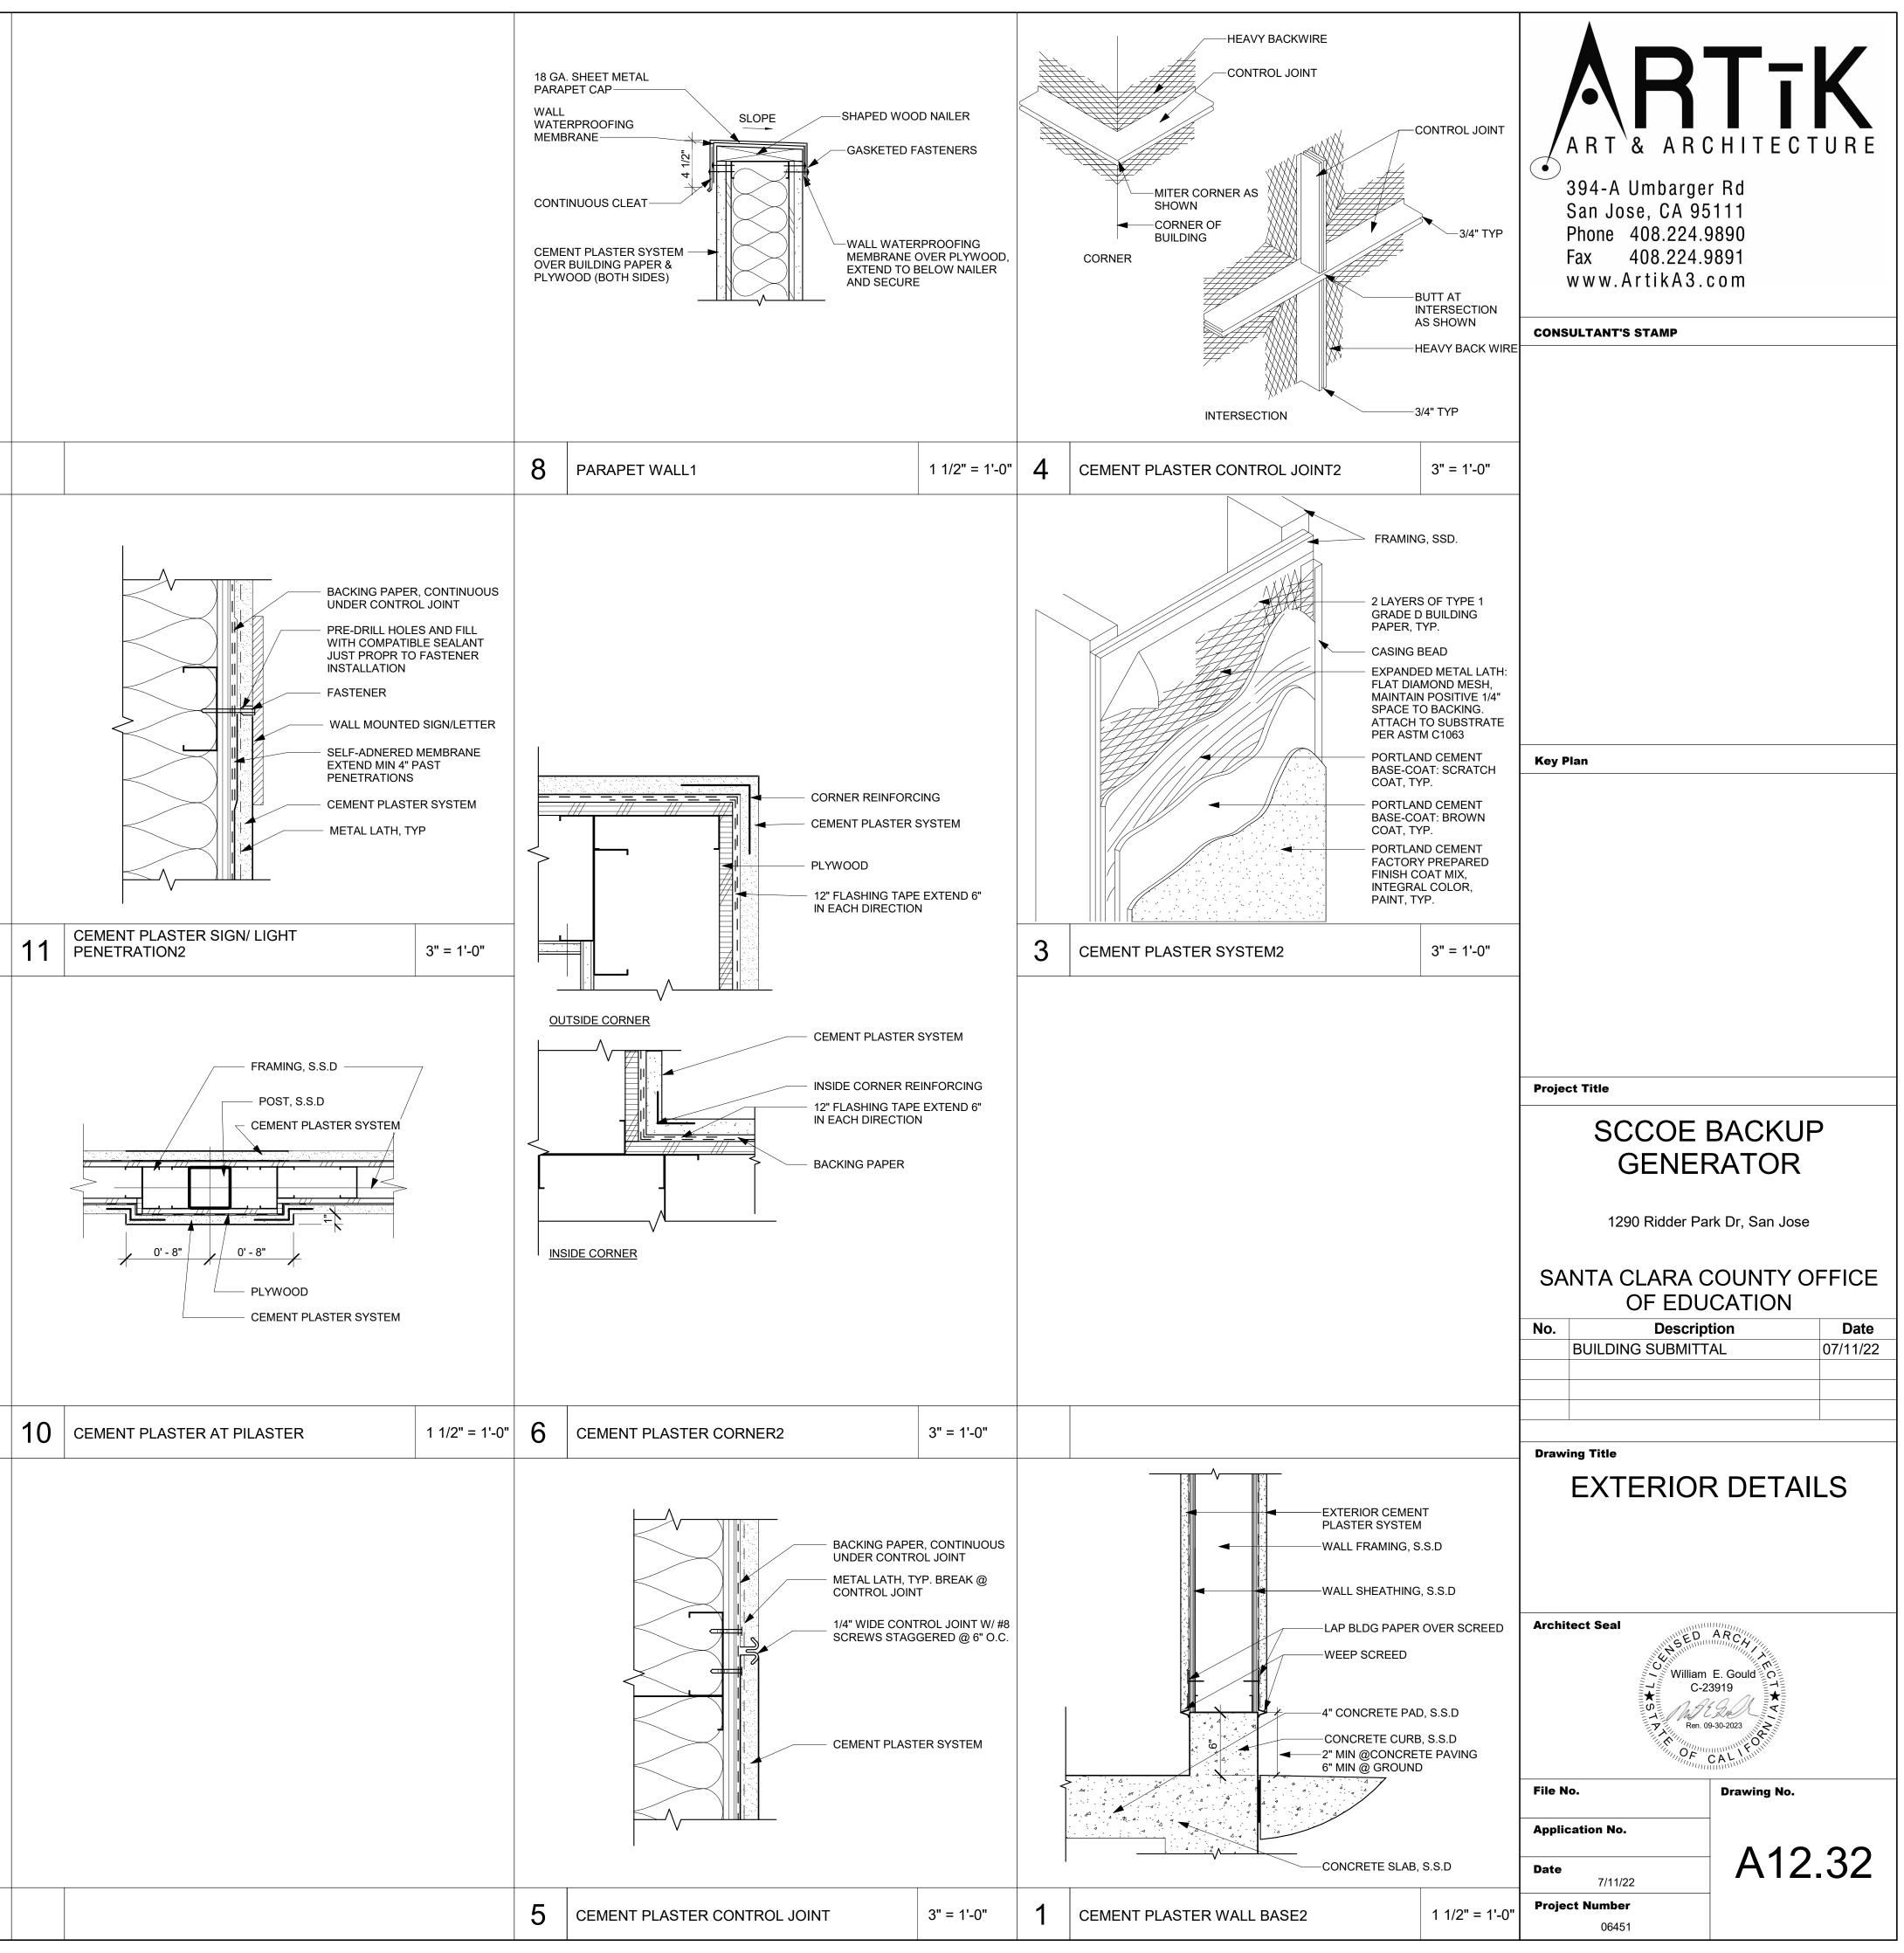

	W/O FLY ASH	W/ UP TO 15% FLY ASH
5000 PSI CONCRETE AT 28 DAYS	.48	0.43
4000 PSI CONCRETE AT 28 DAYS	.55	0.5
3500 PSI CONCRETE AT 28 DAYS	.55	0.5
3000 PSI CONCRETE AT 28 DAYS	.55	0.5
2500 PSI CONCRETE AT 28 DAYS	.55	0.5
2000 PSI CONCRETE AT 28 DAYS	.67	0.60

STRUCTURAL SPECIFICATIONS	SPECIAL INSPECTIONS	TABLE OF CONTENTS	ABBREVIATIONS	
COLD-FORMED METAL FRAMING	THE OWNER SHALL EMPLOY A SPECIAL INSPECTOR DURING CONSTRUCTION ON THE FOLLOWING TYPES OF WORK:		& And A.B. Anchor bolt	
ALL COLD–FORMED METAL FRAMING SHALL BE AS MANUFACTURED BY CLARK STEEL (OR EQUAL) ASTM–A653 Fy = 33 KSI MINIMUM FOR 20 GAGE, & 18 GAGE Fy = 50 KSI FOR 16 GAGE OR BETTER	WELDING — DUCTILE MOMENT-RESISTING STEEL FRAMES. AS REQUIRED BY THE APPLICABLE SECTION OF THE 2013 C.B.C	C. <u>SHEET</u> <u>CONTENT</u>	❻ At ALUM. Aluminum	
LIGHT GAGE METAL CONNECTORS	 ALL STRUCTURAL WELDING, INCLUDING WELDING OF REINFORCING STEEL. 	S0.0 STRUCTURAL SPECIFICATIONS ABBREVIATIONS LEGEND	ARCH. Architect or Architectual BLK. Block BLKG Blocking	ART & ARCHITECTURE
ALL LIGHT GAGE METAL CONNECTORS SHALL BE SIMPSON COMPANY STRONG TIE CONNECTORS, UNLESS NOTED OTHERWISE ON THE DRAWINGS.	EXCEPTIONS:	SYMBOLS LEGEND TABLE OF CONTENTS	BLKG. Blocking BN Boundary Nailing per Schedule/Plan BTWN. Between	\bullet
CONCRETE ALL CONCRETE SHALL HAVE PROPERTIES AS LISTED BELOW.	 WELDING DONE IN A FABRICATOR'S SHOP, APPROVED BY THE CITY BUILDING OFFICIAL. SINGLE PASS FILLET WELDS MAY HAVE PERIODIC INSPECTION PER C.B.C. NOTED OTHERWISE 	S1.0 NORTH GENERATOR FOUNDATION PLAN SOUTH GENERATOR FOUNDATION PLAN	C Channel CANTL. Cantilevered	394-A Umbarger Rd San Jose, CA 95111
MAXIMUM WATER-CEMENT RATIO, BY WEIGHT SHALL BE AS FOLLOWS:	UNLESS ON THE CONTRACT DRAWINGS.	DETAILS	CL or (L Centerline C.J. Construction Joint or Cold Joint	Phone 408.224.9890 Fax 408.224.9891
W/O FLY ASH W/ UP TO 15% FLY ASH 5000 PSI CONCRETE AT 28 DAYS .48 0.43	– DURING ALL ADHESIVE ANCHORING INSTALLATIONS.	SYMBOLS LEGEND	C.J.P. Complete Joint Penetration CLR Clear COL. Column	www.ArtikA3.com
4000 PSI CONCRETE AT 28 DAYS .55 0.5 3500 PSI CONCRETE AT 28 DAYS .55 0.5 3000 PSI CONCRETE AT 28 DAYS .55 0.5	EXPANSION ANCHORS	SYMBOL DESCRIPTION	COLL. Collector CONC. Concrete	CONSULTANT'S STAMP
2500 PSI CONCRETE AT 28 DAYS .55 0.5 2000 PSI CONCRETE AT 28 DAYS .67 0.60	 THE SPECIAL INSPECTOR MUST BE ON THE JOB SITE CONTINUOUSLY DURING ANCHOR INSTALLATION TO VERIFY ANCHOR TYPE, ANCHOR DIMENSIONS, CONCRETE TYPE, CONCRETE COMPRESSIVE STRENGTH, HOLE DIMENSIONS, HOLE CLEANING PROCEDURES, ANCHOR SPACING, EDGE DISTANCES, CONCRETE 		CONN. Connection CONT. Continuous	
APPROXIMATELY 3 OUNCES PER SACK OF CEMENT OF POZZOLITH 300R OR APPROVED EQUAL SHALL BE USED AS A WATER DISPERSING ADDITIVE. AT CONTRACTOR'S OPTION, AN AIR ENTRAINING AGENT CONFORMING TO THE LATEST REVISION OF ASTA SPECIFICATION C 260 MAX RE ADDED TO THE CONCRETE TO PROVIDE SPECIFICATION C 260 MAX RE ADDED TO THE CONCRETE TO PROVIDE SPECIFICATION C 260 MAX RE ADDED TO THE CONCRETE TO PROVIDE SPECIFICATION C 260 MAX RE ADDED TO THE CONCRETE TO PROVIDE SPECIFICATION C 260 MAX RE ADDED TO THE CONCRETE TO PROVIDE SPECIFICATION C 260 MAX RE ADDED TO THE CONCRETE TO PROVIDE SPECIFICATION C 260 MAX RE ADDED TO THE CONCRETE TO PROVIDE SPECIFICATION C 260 MAX RE ADDED TO THE CONCRETE TO PROVIDE SPECIFICATION C 260 MAX RE ADDED TO THE CONCRETE TO PROVIDE SPECIFICATION C 260 MAX RE ADDED TO THE CONCRETE TO PROVIDE SPECIFICATION C 260 MAX RE ADDED TO THE CONCRETE TO PROVIDE SPECIFICATION C 260 MAX RE ADDED TO THE CONCRETE TO PROVIDE SPECIFICATION C 260 MAX RE ADDED TO THE CONCRETE TO PROVIDE SPECIFICATION C 260 MAX RE ADDED TO THE CONCRETE TO PROVIDE SPECIFICATION C 260 MAX RE ADDED TO THE CONCRETE TO PROVIDE SPECIFICATION C 260 MAX RE ADDED TO THE CONCRETE TO PROVIDE SPECIFICATION C 260 MAX RE ADDED TO THE CONCRETE TO PROVIDE SPECIFICATION C 260 MAX RE ADDED TO THE CONCRETE TO PROVIDE SPECIFICATION C ADDITION C 260 MAX RE ADDED TO THE CONCRETE TO PROVIDE SPECIFICATION C ADDITION C ADDIT	THICKNESS, ANCHOR EMBEDMENT AND TIGHTENING TORQUE.	Detail No. S2.1- Sheet Location	CMU Concrete Masonry Unit DBL. Double DF Douglas Fir	
REVISION OF ASTM SPECIFICATION C 260 MAY BE ADDED TO THE CONCRETE TO PROVIDE SPECIFIED AMOUNTS OF ENTRAINED AIR.	 THE SPECIAL INSPECTOR SHALL BE A QUALIFIED PERSON WHO SHALL DEMONSTRATE HIS COMPETENCE, TO THE SATISFACTION OF THE BUILDING OFFICIAL, FOR INSPECTION OF A PARTICULAR TYPE OF CONSTRUCTION OR OPERATION REQUIRING SPECIAL INSPECTION. 		DF Douglas Fir DIA. or Ø Diameter DWG. Drawing(s)	DUQUETTE
CONCRETE ELEMENT MIN. 28 DAY COMPRESSIVE MAX. SIZE AGGREGATE MAX. SLUMP TOTAL AIR STRENGTH (INCHES) CONTENT	DUTIES AND RESPONSIBILITIES OF THE SPECIAL INSPECTOR	View Direction	(E) Existing EA. Each	E N G I N E E R I N G
SLAB ON GRADE *3000 3/4 4 4%±1.5%	 THE SPECIAL INSPECTOR SHALL OBSERVE THE WORK ASSIGNED FOR CONFORMANCE WITH THE APPLICABLE DESIGN DRAWINGS AND SPECIFICATIONS. 	1	EF Edge Fastening ELEV. Elevation	1171 HOMESTEAD ROAD, SUITE 275 SANTA CLARA, CALIFORNIA 95050
*2500 PSI USED FOR DESIGN, NO SPECIAL INSPECTION REQUIRED REINFORCING STEEL	- THE SPECIAL INSPECTOR SHALL FURNISH INSPECTION REPORTS TO THE BUILDING OFFICIAL, THE ENGINEER OR ARCHITECT OF RECORD, AND OTHER DESIGNATED PERSONS. ALL DISCREPANCIES SHALL		EMBED. Embedment EN Edge Nail per Shearwall Schedule EQ. Equal	MAIN LINE: 408.615.9200 WEBSITE: www.duquette-eng.com
BARS FOR REINFORCING SHALL BE GRADE 60 DEFORMED BARS CONFORMING TO ASTM A-615 INCLUDING SUPPLEMENT S1. LAP SPLICES SHALL BE IN ACCORDANCE WITH ACI 318 UNLESS NOTED OTHERWISE ON THE PLANS.	BE BROUGHT TO THE IMMEDIATE ATTENTION OF THE CONTRACTOR FOR CORRECTION, THEN, IF UNCORRECTED, THE PROPER DESIGN AUTHORITY AND TO THE BUILDING OFFICIAL.	Indicates Degree of Slope	EXT. Exterior E.W. Each Way	ED PROFESSIONAL
SLAB MEMBRANE - 15 MIL. MOISTOP MEMBRANE ADHESIVE ANCHORING FOR CONCRETE	 THE SPECIAL INSPECTOR SHALL SUBMIT A FINAL SIGNED REPORT STATING WHETHER THE WORK REQUIRING SPECIAL INSPECTION WAS, TO THE BEST OF HIS KNOWLEDGE, IN CONFORMANCE WITH THE APPROVED PLANS AND SPECIFICATIONS AND THE APPLICABLE WORKMANSHIP PROVISION OF THIS CODE. 	Indicates Sloped Beam, Slab, or Deck. Arrowhead indicates	FDN. Foundation F.F. Finish Floor	S 3019
ADHESIVE ANCHORING FOR CONCRETE EPOXY ADHESIVE SHALL BE SIMPSON SET-XP EPOXY ADHESIVE ICC REPORT ESR-2508. THE PROPORTIONS SHALL BE AS RECOMMENDED BY THE MANUFACTURER FOR THE CONDITION AND USE. PREPARATION OF CONCRETE INCLUDING DRILLING		direction.	FLR. Floor FN Field Nailing per Schedule F.O.H.C. Free of Heart Center	EXP. 3-31-2023
OF HOLES FOR ANCHORS AS WELL AS EPOXY ANCHOR INSTALLATION SHALL BE AS RECOMMENDED BY THE MANUFACTURER.		6'−0"±•─── Indicates estimated dimension. For Exact Dimension see Architect	F.O.H.C. Free of Heart Center F.P. Full Penetration FRMG. Framing	* STRUCENT
STRUCTURAL STEEL AND MISCELLANEOUS IRON ALL STRUCTURAL STEEL AND MISCELLANEOUS IRON SHALL RECEIVE SHOP PRIME COAT.			FTG. Footing ga. Gage (Gauge)	OF CALIFOR
INDIVIDUAL SPECIFICATIONS ARE AS FOLLOWS. 1.) HOLLOW STRUCTURAL STEEL AND TUBE STEEL - ASTM A500, GRADE B, Fy = 46ksi		□ Indicates 2x with strut from roof to wall below or from ceiling	GALV. Galvanized G.I. Galvanized Iron	DE Job No.: 22-0020.1 Key Plan
2.) <u>STEEL PIPE</u> – ASTM A53, TYPE E OR S, GRADE B, w/ SULFUR NOT EXCEEDING .05%, Fy = 35ksi MACHINE BOLTS, ANCHOR BOLTS AND STUDS		to roof above	GLB Glulam Beam HD Holdown HDR Header	
ASTM A307 THREADED RODS		Indicates Field Weld, Shop Weld when not shown.	HGR Hanger HORIZ. Horizontal	S2 - NORTH S1 - SOUTH GENERATOR GENERATOR
ASTM F1554 GRADE A36 WELDING		TYP. Weld Notes	H.S.B. High Strength Bolt(s) H.S.S. Hollow Structural Section	(E) E BLDG #2
ALL WELDING SHALL BE PERFORMED BY CERTIFIED WELDERS PER AWS "STANDARD QUALIFICATION PROCEDURE" TO PERFORM THE TYPE OF WORK REQUIRED. ALL WELDING SHALL BE IN ACCORDANCE WITH AWS WELDING CODE. ARC WELDING ELECTRODES SHALL BE E70 SERIES. WELDING SHALL BE INSPECTED AS REQUIRED BY THE		Weld Type	HT Height INT. Interior I.M.R.F. Intermediate Moment Resisting Frames	
CALIFORNIA BUILDING CODE.		Weld Size Weld all sides	I.M.R.F. Intermediate Moment Resisting Frames LBS. or # Pounds LSL Laminated Strand Lumber	(E) N BLDG #3 (E) S BLDG
CONSTRUCTION CONTRACTOR AND HIS SUBCONTRACTORS AGREE THAT IN ACCORDANCE WITH GENERALLY ACCEPTED CONSTRUCTION PRACTICES, CONSTRUCTION CONTRACTOR AND HIS SUBCONTRACTORS WILL BE REQUIRED TO ASSUME		Refer to AISC, Latest Edition, for All Weld Types & Symbols	LVL Laminated Veneer Lumber (L.L.H.) Long Leg Horizontal	
SOLE AND COMPLETE RESPONSIBILITY FOR JOB SITE CONDITIONS DURING THE COURSE OF CONSTRUCTION OF THE PROJECT, INCLUDING SAFETY OF ALL PERSONS AND PROPERTY; THAT THIS REQUIREMENT SHALL BE MADE TO APPLY CONTINUOUSLY AND NOT LIMITED TO NORMAL WORKING HOURS, AND CONSTRUCTION CONTRACTOR AND HIS		∕ <u>∖</u> rRevision Number	(L.L.V.) Long Leg Vertical MAX. Maximum M.P. Machine Polt(c)	
SUBCONTRACTORS FURTHER AGREE TO DEFEND, INDEMNIFY AND HOLD DESIGN PROFESSIONAL HARMLESS FROM ANY AND ALL LIABILITY, REAL OR ALLEGED, IN CONNECTION WITH THE PERFORMANCE OF WORK ON THIS PROJECT, EXCEPT LIABILITY ARISING FROM THE SOLE NEGLIGENCE OF DESIGN PROFESSIONAL.			M.B. Machine Bolt(s) MC Miscellaneous Channel MECH. Mechanical	
LIABILITY ARISING FROM THE SOLE NEGLIGENCE OF DESIGN PROFESSIONAL.		Affected Region due to Current Revision.	MFR. Manufacturer MIN. Minimum	
THE CONTRACTOR OR SUBCONTRACTOR SHALL FIELD VERIFY ALL EXISTING CONDITIONS PRIOR TO BEGINNING CONSTRUCTION AND OR ORDERING MATERIAL, ANY DISCREPANCIES DISCOVERED SHALL BE BROUGHT TO THE ATTENTION OF THE ENGINEER IMMEDIATELY.			(N) New N.T.S. Not To Scale	
OF THE ENGINEEN IMIMEDIATEET.			o/ Over O.C. On Center O.M.R.F. Ordinary Moment Resisting Frame	SCCOE BACKUP
	o_ __		0.M.K.F. Orainary Moment Resisting Frame 0.F. Outside Face 0.H. Opposite Hand	GENERATOR
3/8" MAX GAP BETWEEN STUD AND TOP PLATE AT BEARING WALLS	$2^{1/2}$		OSB Oriented Strand Board PL. or R Plate	1290 Ridder Park Dr, San Jose
16 GAGE TRACK			PLYWD. Plywood P.J.P. Partial Joint Penetration P.P. Partial Penetration	
#10_SELE-DRILLING	CTDAD		P.P. Partial Penetration PSL Parallel Strand Lumber PTDF Pressure Treated Douglas Fir	SANTA CLARA COUNTY OFFICE OF EDUCATION
SCREWS AT EACH STUD, TYP. 5" WIDE x 3'-0" LONG 16 GAGE W/ (14)-#10 SELF DRILLING SCR EACH SIDE OF SPLICE (28 TOTA	$= STRAP - 4^* wdey 16 call flat at Mid Height of Wall fach + 4 - 4 - 4 - 4 - 4 - 4 - 4 - 4 - 4 - 4$	BACK-TO-BACK 16 GAGE STUD FASTEN TOGETHER w/ #10 SELF-DRILLING SCREWS AT 12" O.C.	REINF. Reinforcing or Reinforcement REQ. Require or Required	No. Description Date
	TO SUPPORT ARCHITECTURAL ACCESSORIES (U.N.O.)		RDWD. Redwood S.A.D. See Architectural Drawings SECT. Section	BUILDING SUBMITTAL 07/11/22
		TO STUD EACH SIDE	SECT. Section SHT. Sheet SIM. Similar	
(4)-#10 AT CORNER LAPS &		COPE FLANGE OF BOXED HEADER, TYP.	SN Sill Nail SMRF Special Moment Resisting Frame	
SCHEDULE PLATES COUPE FLANGES OF INTERSECTING TRACK		16 GAGE TRACK, TYP. AT DOOR & WINDOW JAMB w/ #10 SELF-DRILLING SCREWS @ 24" O.C. EACH	SPECS. Specifications SQ. or ¢ Square S.S. Stainless Steel	Drawing Title STRUCTURAL SPECS.
MINIMUM REQUIRED FASTENING (UNLESS DETAILED OTHERWISE) #10 @ 12" O.C. STAGGERED, +	SECTIC	N SÍDE TO DOUBLE STUD	S.S. Stainless Steel SP Standard Pipe XSP Extra Strong Pipe	ABBREVIATIONS
#10 @ 12 0.C. STAGGERED, (2)-#10 SELF-DRILLING SCREWS #10 @ 12 0.C. STAGGERED, HI BACK-TO-BACK 16 GAGE STUDS		SCALE: $1'' = 1' - 0''$	XXSP Double Extra Strong Pipe STAGG Staggered	SYMBOLS LEGEND
(3)-10 SELF-DRILLING SCREWS AT DOOR & WINDOW JAMBS, TYP.	WINDOW OPENING	\mathbf{C}	STD. Standard STIFF. Stiffener STI Staal	TABLE OF CONTENTS
#10 SELF-DRILLING SCREWS @ 12" O.C. EACH FLANGE WALL STUD, TYP., PER SCHEDULE		SHEAR PLY WHERE OCCURS SEE PLANS	STL. Steel T&B Top and Bottom T.&G. Tongue and Groove	Architect Seal
(4)-#10 SELF-DRILLING SCREWS EACH STUD #10 EA. SIDE, EA. STUD TO TRACK, TYP.		AND SHEARWALL SCHEDULE	TN Toe Nail T.O.C. Top of Concrete or Top of Curb	
#10 SELF-DRILLING SCREWS STAGGERED @ 12" O.C.		#10 SELF-DRILLING SCREWS @ 12" O.C.	T.O.P. Top of Plywood T.O.S. Top of Steel	
(2)-#10 SELF-DRILLING SCREWS TOP & BOTTOM MIN. @ 48" O.C. MAX. / BOTTOM TRACK TYP. U.N.O. / BOTTOM TRACK		16 GA. TRACK	TS Tube Steel TYP. Typical	
#10 SELF-DRILLING SCREWS @ 12" O.C.		C12 x 14 GAGE	U.N.O. Unless Noted Otherwise VERT. Vertical V.I.F. or * Verify In Field	
	3" MIN. 5" MAX. 3" MIN. 5" MAX.	C6 x 16 GA. TYP. U.N.O.	w/o Without	File No. Drawing No.
BETWEEN BACK TO BACK STUDS w/ (6)-#10 SELF DRILLING SCREWS AT BACK-TO-BACK STUDS &	PROVIDE 1/2" GROUT IF REQUIRED.	16 GA. TRACK	W.P. Work Point WT. Weight	Application No.
#10 SCREW (4)- ¼"¢ x 2" TAPCON CONCRETE SCREWS TO FOUNDATION, TYP. AT DOOR & WINDOW JAMB	1. SHEAR PLY NOT SHOWN FOR CLARITY.			Date S0.0
G SCHEDULE (1) TYPICAL BEARING/STUD WALL				7/11/22 Project Number
	SCALE: 1/2" = 1'-0"	SCALE: $1'' = 1' - 0''$		06451 Plot Date 6/17/2022 4:37:51 PM

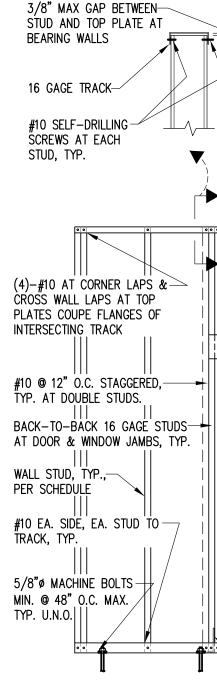


FASTENING SCHE FASTENED CONNECTION DESCRIPTION (UNLESS JOISTS TO TRACK (2)**-**#10 (3)–10 S BLOCKING TO TRACK OR HEADER #10 SELF TRACK AT BOXED HEADER TRACK LEDGER TO STUD (4)-**#**10 #10 SELF BACK-TO-BACK MEMBERS (2)**-**#10 TRACK TO STUD JOIST PARALLEL TO TRACK #10 SELF SIMPSON ANGLES & CONNECTORS SEE SIMF

1/2" MINIMUM EDGE DISTANCE, TYPICAL

3 FULL THREAD MIN.

MINIMUM FASTENING SC

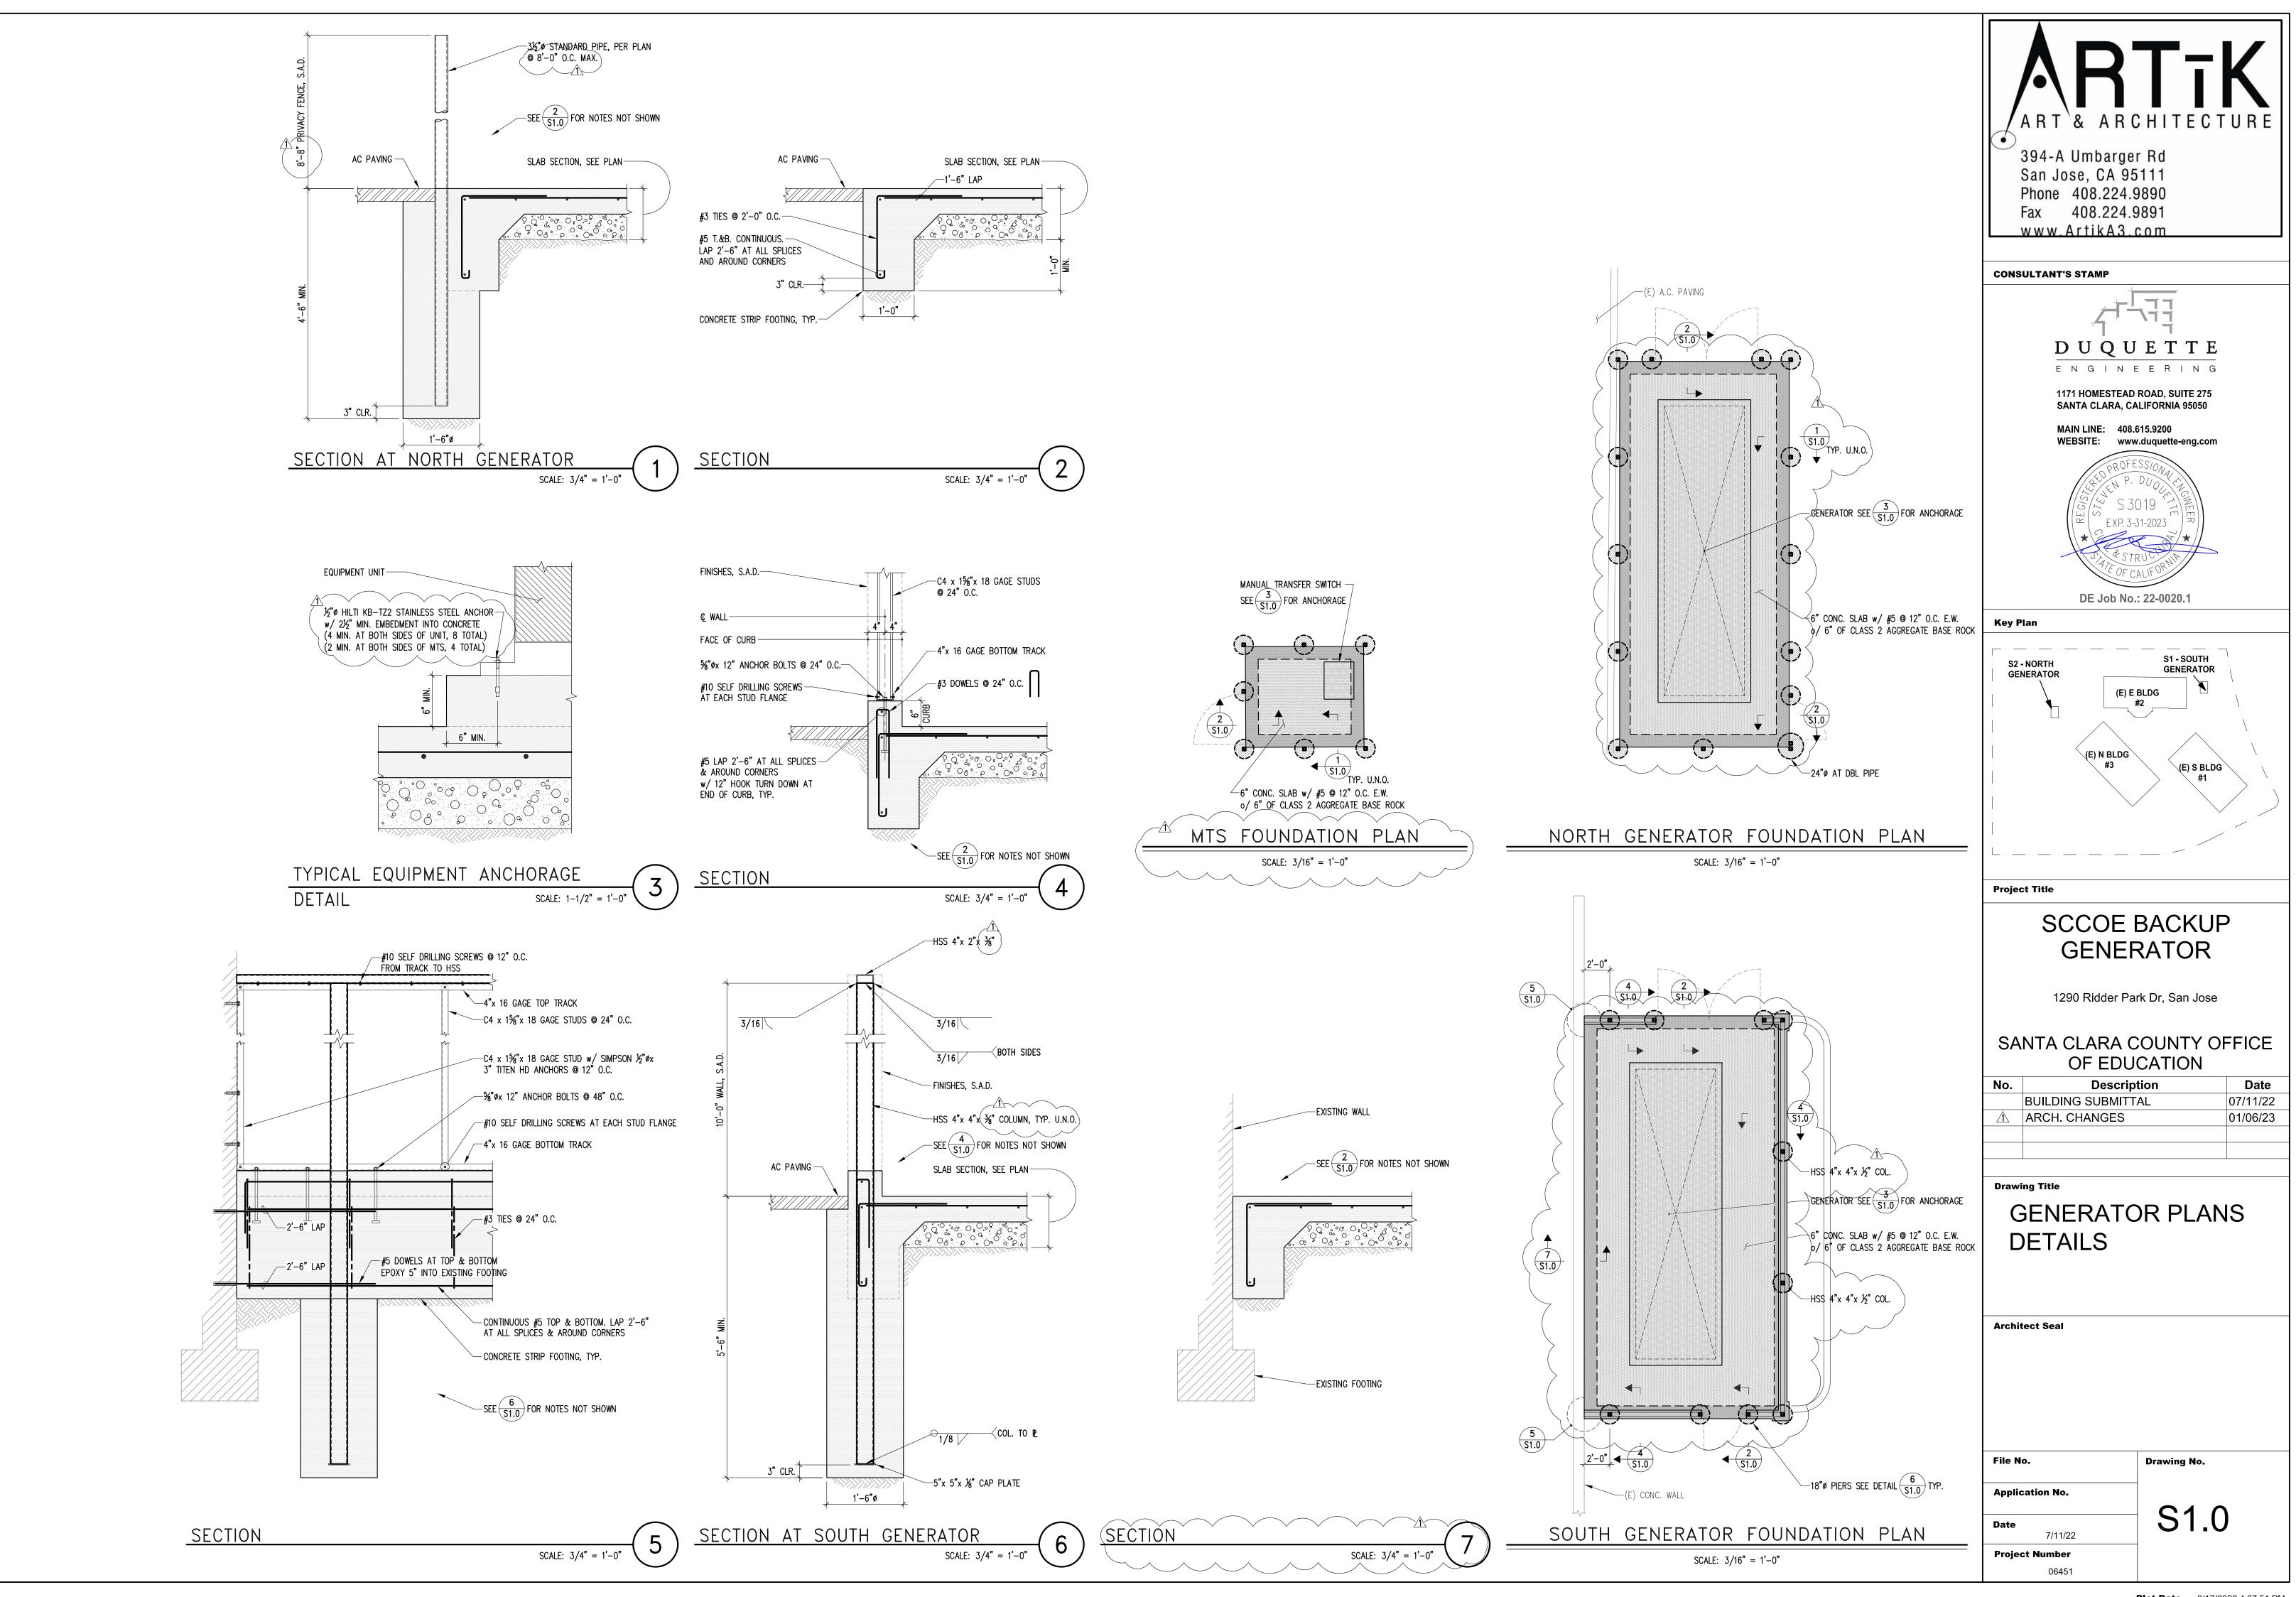

STANDARD GRADING AND DRAINAGE PLAN NOTES

NOTE: THIS DRAWING IS APPROVED SUBJECT TO:

- 1. ALL GRADING IS SUBJECT TO OBSERVATION BY THE CITY. THE PERMITTEE OR REPRESENTATIVE SHALL NOTIFY THE CITY OF SAN JOSE DEPARTMENT OF PUBLIC WORKS PROJECT INSPECTOR AT LEAST 48 HOURS BEFORE START OF ANY GRADING. THE PROJECT INSPECTOR IS ____ VOICEMAIL (408) ____
- 2. APPROVAL OF THIS PLAN APPLIES ONLY TO: (A) THE EXCAVATION, PLACEMENT, AND COMPACTION OF NATURAL EARTH MATERIALS.
- (B) THE INSTALLATION OF ON-SITE (I.E. PRIVATE PROPERTY) STORM WATER CONVEYANCE AND TREATMENT FACILITIES THAT ARE OUTSIDE OF THE 5-FOOT BUILDING ENVELOPE, AND
- (C) THE INSTALLATION OF RETAINING STRUCTURES THAT ARE INDEPENDENT OF ANY BUILDING STRUCTURE (SEE NOTE 3 BELOW). THIS APPROVAL DOES NOT CONFER ANY RIGHTS OF ENTRY TO EITHER PUBLIC PROPERTY OR THE PRIVATE PROPERTY OF OTHERS. APPROVAL OF THIS PLAN ALSO DOES NOT CONSTITUTE APPROVAL OF ANY IMPROVEMENTS WITH THE EXCEPTION OF THOSE LISTED ABOVE, PROPOSED IMPROVEMENTS. WITH THE EXCEPTION OF THOSE LISTED ABOVE, ARE SUBJECT TO REVIEW AND APPROVAL BY THE RESPONSIBLE AUTHORITIES AND ALL OTHER REQUIRED PERMITS SHALL BE OBTAINED.
- 3. UNLESS OTHERWISE NOTED ON THE PLAN, ANY DEPICTION OF ANY RETAINING STRUCTURE ON THIS PLAN SHALL NOT CONSTITUTE APPROVAL FOR CONSTRUCTION OF THE RETAINING STRUCTURE UNLESS A SEPARATE STRUCTURAL REVIEW BY THE DEPARTMENT OF PUBLIC WORKS IS COMPLETED AND APPROVED.
- 4. IT SHALL BE THE RESPONSIBILITY OF THE PERMITTEE OR AGENT TO IDENTIFY, LOCATE AND PROTECT ALL UNDERGROUND FACILITIES.
- 5. THE PERMITTEE OR AGENT SHALL MAINTAIN THE STREETS, SIDEWALKS, AND ALL OTHER PUBLIC RIGHTS-OF-WAY IN A CLEAN, SAFE, AND USABLE CONDITION. ALL SPILLS OF SOIL, ROCK, OR CONSTRUCTION DEBRIS SHALL BE REMOVED FROM THE PUBLICLY OWNED PROPERTY DURING CONSTRUCTION AND UPON COMPLETION OF THE PROJECT. ALL ADJACENT PROPERTY, PRIVATE OR PUBLIC, SHALL BE MAINTAINED IN A CLEAN, SAFE, AND USABLE CONDITION.
- 6. ALL GRADING SHALL BE PERFORMED IN SUCH A MANNER AS TO COMPLY WITH THE STANDARDS ESTABLISHED BY THE AIR QUALITY MANAGEMENT DISTRICT FOR AIRBORNE PARTICULATES.
- 7. THIS PROJECT HAS BEEN DESIGNED TO COMPLY WITH THE FLOOD HAZARD AREA REGULATIONS AS STATED IN CHAPTER 17.08 OF THE SAN JOSE MUNICIPAL CODE.
- 8. ALL KNOWN WELL LOCATIONS ON THE SITE HAVE BEEN INCLUDED. SUCH WELLS SHALL BE MAINTAINED OR ABANDONED ACCORDING TO CURRENT REGULATIONS ADMINISTERED BY THE SANTA CLARA VALLEY WATER DISTRICT. CALL (408) 265-2600 EXTENSION 2660 TO ARRANGE FOR DISTRICT OBSERVATION OF ALL WELL ABANDONMENTS.
- 9. IN THE EVENT THAT HUMAN REMAINS AND/OR CULTURAL MATERIALS ARE FOUND, ALL PROJECT RELATED CONSTRUCTION SHOULD CEASE WITHIN A 100-FOOT RADIUS. THE CONTRACTOR SHALL, PURSUANT TO SECTION 7050.5 OF THE HEALTH AND SAFETY CODE AND SECTION 5097.94 OF THE PUBLIC RESOURCES CODE OF THE STATE OF CALIFORNIA, NOTIFY THE SANTA CLARA COUNTY CORONER IMMEDIATELY.
- 10. THIS PLAN DOES NOT APPROVE THE REMOVAL OF TREES. APPROPRIATE TREE REMOVAL PERMITS AND METHODS OF TREE PRESERVATION SHOULD BE OBTAINED FROM THE CITY'S PLANNING DEPARTMENT AND THE CITY ARBORIST.
- 11. FOR NON-RESIDENTIAL PROJECTS, AN NON-HAZARDOUS EXPORT RESULTING FROM PROJECT RELATED EXCAVATION OR LAND CLEARING SHALL BE 100% REUSED AND RECYCLED PER CALIFORNIA GREEN BUILDING STANDARDS CODE SECTION 5.408.
- 12. BOLT-DOWN STORM DRAIN MANHOLE COVERS SHALL BE USED WHEN STORM DRAIN MANHOLES ARE NOT IN THE STREET (I.E. WHEN LOCATED IN LANDSCAPED AREAS, SIDEWALKS, ON-SITE EASEMENTS, ETC.).
- 13. STORM DRAIN INLETS:
- A. STENCILING LOCATION: CONTRACTOR SHALL STENCIL ALL STORM DRAIN INLETS AND CATCH BASINS WITH THE "NO DUMPING FLOWS TO NEIGHBORHOOD CREEK" STENCIL. THE "NO DUMPING" MESSAGE SHOULD BE APPLIED TO BOTH THE TOP OF THE CURB AND THE FACE OF THE CURB NEXT TO THE STORM DRAIN INLET, PREFERABLY ON THE LEFT SIDE. IF THIS IS NOT FEASIBLE, PLACE THE MESSAGE IN THE STREET IN FRONT OF THE INLET.
- B. PREVIOUSLY MARKED INLETS: INLETS THAT HAVE ALREADY BEEN LABELED WITH PERMANENT PLASTIC "NO DUMPING" MARKERS DO NOT NEED STENCILING. IF THE INLET HAS BEEN PREVIOUSLY STENCILED, PAINT OVER THE OLD PAINT AND APPLY A FRESH STENCIL.
- C. COLORS AND MATERIALS: USE WHITE TRAFFIC STRIPING PAINT FOR THE BACKGROUND AND BLUE TRAFFIC STRIPING PAINT FOR THE LETTERING. TRAFFIC STRIPING PAINT CAN BE PURCHASED AT COMMERCIAL PAINT RETAILERS OR THROUGH SPECIALTY TRAFFIC CONTROL OR CONSTRUCTION SUPPLIERS. THE USE OF ORDINARY PAINT FOR STORM DRAIN MARKING IS NOT ALLOWED. THE STENCILS MAY BE OBTAINED, AT NO CHARGE, THROUGH THE ENVIRONMENTAL SERVICE DEPARTMENT. CONTACT AMBER SCHAT AT 408-945-3000.
- 14. THE CIVIL ENGINEER INFORMATION AND STATEMENTS:
- A. THE CIVIL ENGINEER FOR THIS PROJECT IS:
- MARK SORENSON UNDERWOOD & ROSENBLUM, INC.
- 1630 OAKLAND ROAD, SUITE A114 SAN JOSE, CA. 95131.
- (408) 453-1222
- B. THIS ROUGH GRADING PLAN HAS BEEN PREPARED UNDER THE DIRECTION OF A LICENSED ENGINEER AND DESIGNED BASED ON THE RECOMMENDATIONS OF THE REFERENCE PROJECT GEOTECHNICAL REPORT.
- C. THE STORMWATER CONVEYANCE SYSTEM HAS BEEN DESIGNED IN ACCORDANCE WITH THE APPROPRIATE BUILDING AND PLUMBING CODES OR HAS BEEN PROVEN TO BE DESIGNED WITH ADEQUATE CAPACITY THROUGH SIGNED AND SEALED HYDRAULIC CALCULATIONS. 15. SOILS ENGINEER INFORMATION AND REQUIREMENTS:
- A. –
- B. C. ALL GRADING WORK SHALL CONFORM TO THE RECOMMENDATION OF THE PROJECT GEOTECHNICAL REPORT AND/OR THE PROJECT SOIL ENGINEER.
- D. ALL GRADING WORK SHALL BE OBSERVED AND APPROVED BY THE SOIL ENGINEER. THE SOIL ENGINEER SHALL BE NOTIFIED AT LEAST 48 HOURS BEFORE BEGINNING ANY GRADING. UNOBSERVED AND/OR UNAPPROVED GRADING WORK SHALL BE REMOVED AND REPLACED UNDER OBSERVATION.
- 16. A POST CONSTRUCTION "FINAL" REPORT IS REQUIRED BY THE DIRECTOR OF PUBLIC WORKS FROM A CIVIL ENGINEER RETAINED BY THE OWNER TO OBSERVE THE CONSTRUCTION STATING:
- A. "THAT THE CONSTRUCTION CONFORMS TO THE LINES AND GRADES ON THE APPROVED PLANS;" OR
- B. "THAT ALL SIGNIFICANT CHANGES WERE REVIEWED AND APPROVED IN ADVANCE BY THE DEPARTMENT OF PUBLIC WORKS" AND THE CIVIL ENGINEER SHALL SUBMIT A "RECORD DRAWING" PLAN.
- 17. A POST CONSTRUCTION "FINAL" REPORT IS REQUIRED BY THE DIRECTOR OF PUBLIC WORKS FROM A SOIL ENGINEER AND ALSO FROM AN ENGINEERING GEOLOGIST IF THE PROJECT IS IN A GEOLOGIC HAZARD ZONE, STATING:
- A. "THAT THE ANTICIPATED CONDITIONS AND MATERIALS AND ACTUAL SITE CONDITIONS AND MATERIALS WERE COMPATIBLE," AND SUPPLY SUPPORTING DATA: OR
- B. "THAT THE DESIGN WAS MODIFIED TO MEET THE NEW CONDITIONS AND WAS REVIEWED AND APPROVED IN ADVANCE BY THE DEPARTMENT OF PUBLIC WORKS;" AND PROVIDE SUPPORTING DATA FOR THESE STATEMENTS.
- 18. ACCORDING TO THE CITY'S WASTE WATER ORDINANCE, THE USE OF POTABLE (PIPED OR HYDRANT) WATER FOR BUILDING OR CONSTRUCTION PURPOSES INCLUDING CONSOLIDATION OF BACKFILL OR DUST CONTROL IS PROHIBITED. RECLAIMED WATER IS AVAILABLE AT MULTIPLE LOCATIONS ACROSS THE CITY. TO CERTIFY FOR A RECYCLED WATER METER, PLEASE CALL LYLE FROHMAN AT (408) 794-6805.
- AN APPLICATION FOR AN EXCEPTION PERMIT TO APPROVE USE OF HYDRANT WATER CAN BE CONSIDERED IN THE PW DEVELOPMENT SERVICES OFFICE. FAX-BACK SERVICE IS PROVIDED FOR THIS PERMIT APPLICATION -- CONTACT (408) 535-7802.
- 19. A HAUL ROUTE PERMIT IS REQUIRED FOR ALL PROJECTS MOVING MORE THAN 10,000 C.Y. OF EARTH. THIS GRADING PERMIT IS INVALID WITHOUT THE HAUL ROUTE PERMIT, HAUL ROUTE PERMITS SHALL BE OBTAINED FROM THE CITY'S TRANSPORTATION DEPARTMENT.
- 20. GRADING WILL NOT BE ALLOWED BETWEEN OCTOBER 1ST AND APRIL 30TH OF ANY YEAR WITHOUT EROSION CONTROL PLANS AND MEASURES APPROVED BY THE DIRECTOR OF PUBLIC WORKS. STORMWATER POLLUTION PREVENTION MEASURES IN ACCORDANCE WITH CITY SPECIFICATIONS AND WITH THE DOCUMENT "CLEAN BAY BLUEPRINT" SHALL BE IMPLEMENTED THROUGHOUT THE YEAR TO THE SATISFACTION OF THE DIRECTOR OF PUBLIC WORKS.
- 21. A POST CONSTRUCTION "AS-BUILT" PLAN IS REQUIRED BY THE DIRECTOR OF PUBLIC WORKS FROM A CIVIL OR SOILS ENGINEER RETAINED BY THE OWNER TO PROVIDE THE FINAL HORIZONTAL AND VERTICAL LOCATIONS OF THE IMPROVEMENT APPROVED WITH THIS PLAN. SUCH IMPROVEMENTS INCLUDE SUBDRAINS, ON-SITE STORM WATER CONVEYANCE AND TREATMENT SYSTEMS, AND ON-SITE RETAINING STRUCTURES.

GRADING AND DRAINAGE PLANS FOR SSCOE BACKUP GENERATOR SANTA CLARA COUNTY OFFICE OF EDUCATION 1290 RIDDER PARK DR SAN JOSE, CALIFORNIA


	SHEET INDEX
4 C2	COVERSHEET N BUILDING DEMOLITION PLAN S BUILDING DEMOLITION PLAN N BUILDING GRADING AND UTILITY PLAN S BUILDING GRADING AND UTILITY PLAN
6 C3	DETAILS


APPROVED F AND DRAIN/ DEPARTMENT OF CITY OF SAN JC	PUBLIC WORKS
PROJECT ENGINEER	DATE


22- -GR PERMIT NUMBER

EXPIRATION DATE


EARTH	EARTH WORK QUANTITIES				
() CUT:(CY			
FILL:	$\overline{\mathbf{v}}$	CY			
EXPORT:	0	CY			
NOTE: EARTHWORK QUANTITIES SHOWN ARE APPROXIMATE. IT SHALL BE THE CONTRACTOR'S RESPONSIBILITY TO INDEPENDENTLY ESTIMATE QUANTITIES FOR HIS/HER OWN USE.					

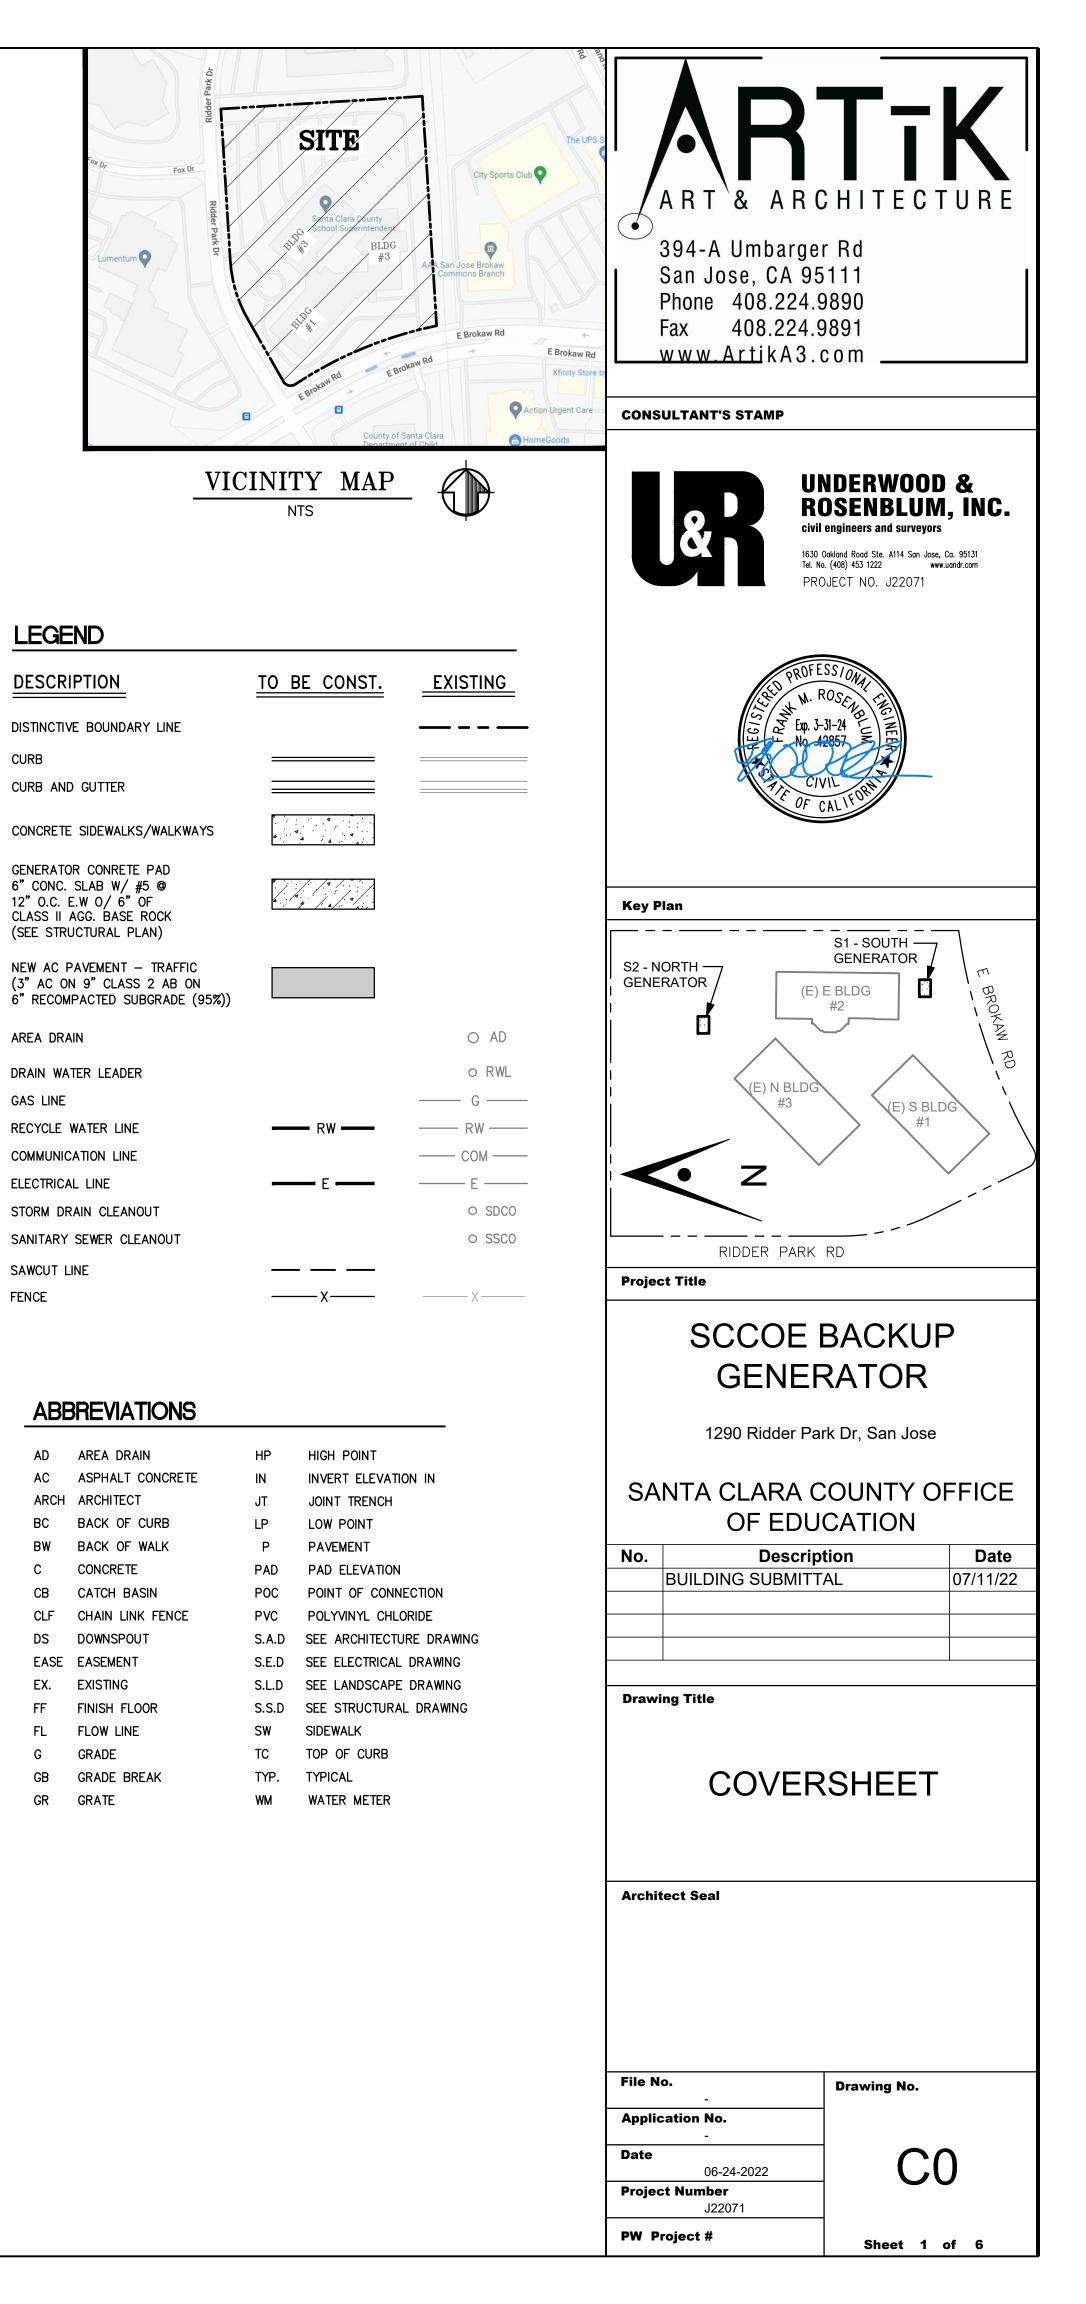

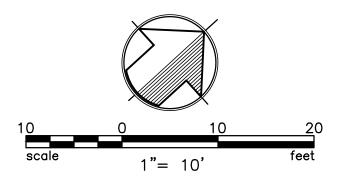

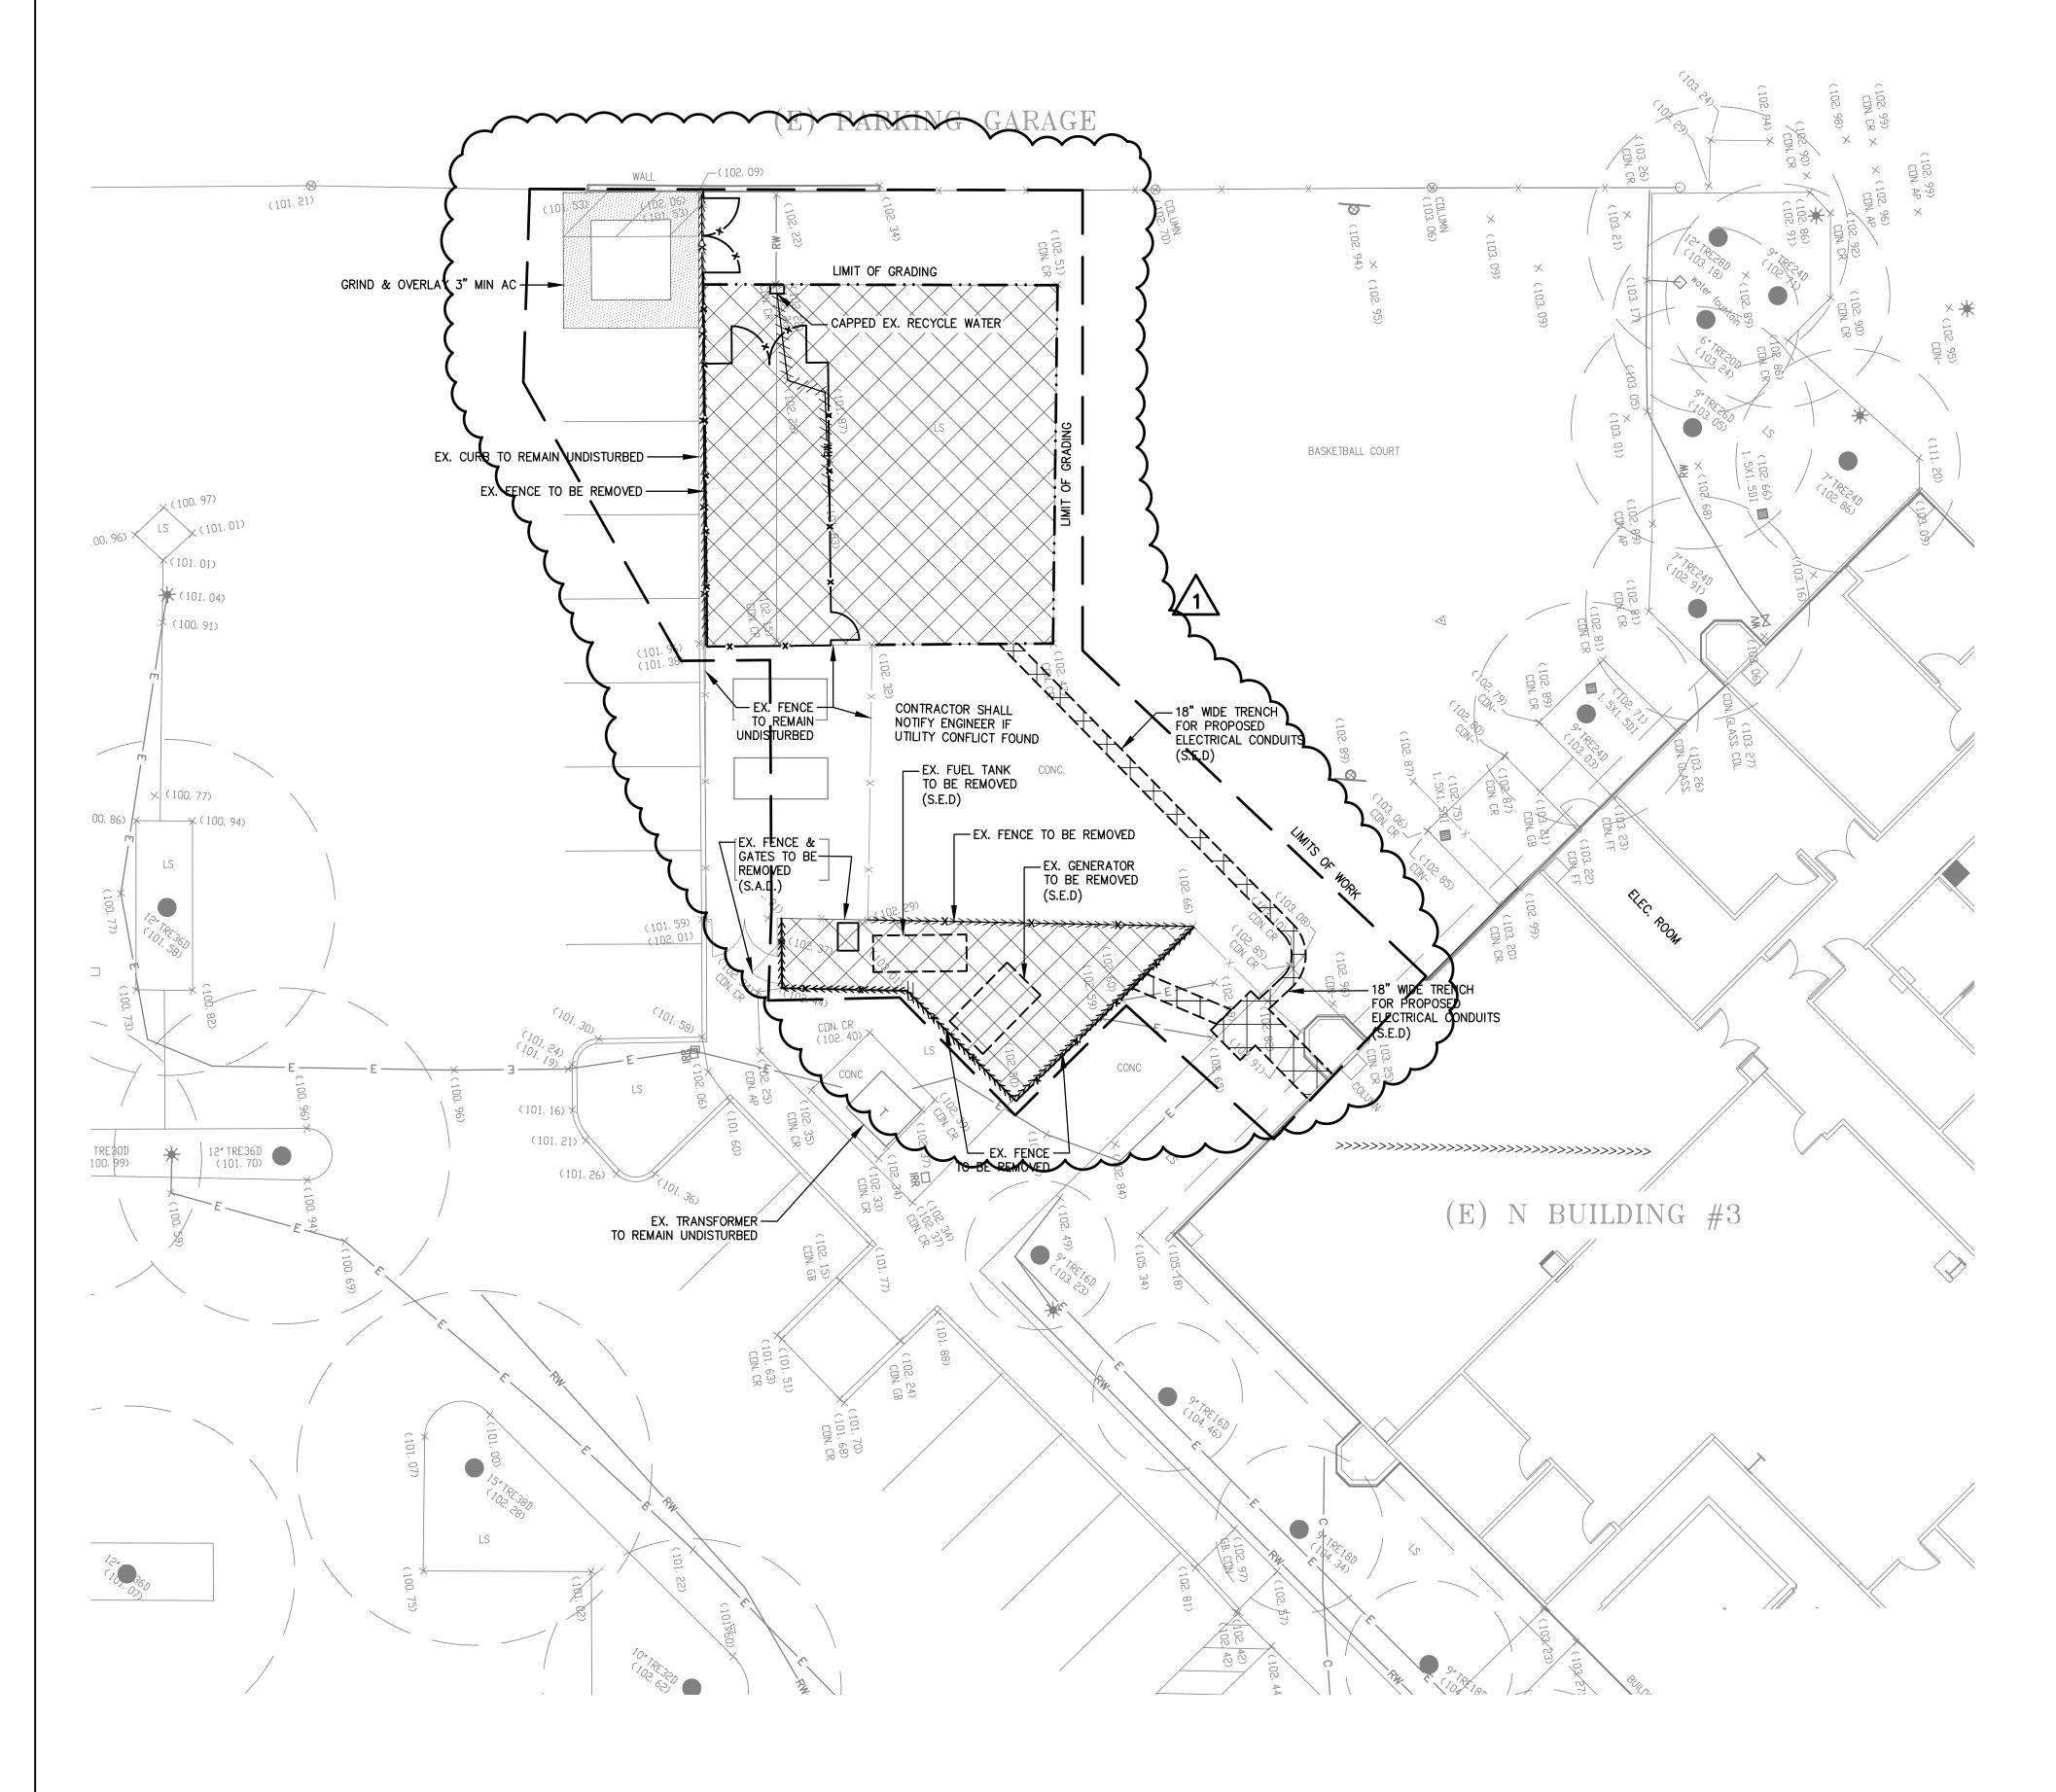




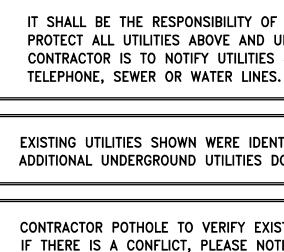

DEMOLITION NOTES: "FOR INFORMATION ONLY"

- STARTING WORK.
- 2. ALL CONTRACTORS SHALL CALL U.S.A. (CA. 1-800-642-2444) 48 HOURS BEFORE DIGGING, AND OBTAIN AN IDENTIFICATION NUMBER (SECTION 4210.1 OF THE GOVERNMENT CODE).
- 3. HAZARDOUS MATERIALS: UPON DISCOVERY OF HAZARDOUS MATERIAL, THE CONTRACTOR SHALL PROMPTLY NOTIFY THE CITY IN WRITING OF ANY:
- A. MATERIAL THAT THE CONTRACTOR BELIEVES MAY BE MATERIAL THAT IS HAZARDOUS WASTE, AS DEFINED IN SECTION 25117 OF THE HEALTH AND SAFETY CODE, THAT IS REQUIRED TO BE REMOVED TO A CLASS I, CLASS II, OR CLASS III DISPOSAL SITE IN ACCORDANCE WITH PROVISIONS OF EXISTING LAW.
- INDICATED.
- C. UNKNOWN PHYSICAL CONDITIONS AT THE SITE OF ANY UNUSUAL NATURE, DIFFERING FROM THOSE ORDINARILY ENCOUNTERED AND GENERALLY RECOGNIZED AS INHERENT IN WORK OF THE CHARACTER PROVIDED FOR IN THE CONTRACT: THE OWNER WILL INVESTIGATE THE SUSPECTED CONDITION AND, AS NECESSARY, INITIATE FURTHER ANALYSIS OF THE PROBLEM. IF REMEDIATION IS REQUIRED, A REMEDIATION PLAN WILL BE PREPARED.
- 4. IN THE EVENT THAT HUMAN REMAINS AND/OR CULTURAL MATERIALS ARE FOUND, ALL PROJECT- RELATED CONSTRUCTION SHOULD CEASE WITHIN A 100-FOOT RADIUS. THE CONTRACTOR SHALL. PURSUANT TO SECTION 7050.5 OF THE HEALTH AND SAFETY CODE. AND SECTION 5097.94 OF THE PUBLIC RESOURCES CODE OF THE STATE OF CALIFORNIA. NOTIFY THE SANTA CLARA COUNTY CORONER IMMEDIATELY.
- 5. CONTRACTOR SHALL REMOVE ALL U.S.A. MARKINGS AS SOON AS THEY ARE NO LONGER NEEDED. REMOVAL OF PAINT SHALL BE BY HIGH WATER PRESSURE METHOD ONLY.
- 6. CONTRACTOR IS RESPONSIBLE FOR CONTACTING APPROPRIATE UTILITY AGENCY PRIOR TO DEMOLITION OF ANY EXISTING UTILITIES.
- 8. CONTRACTOR TO CONTROL DUST DURING DEMOLITION.
- 9. CONTRACTOR TO RECYCLE MATERIALS WHENEVER POSSIBLE.

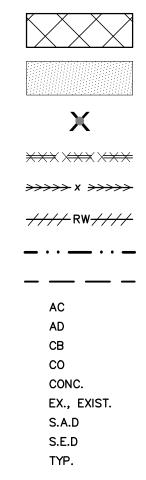



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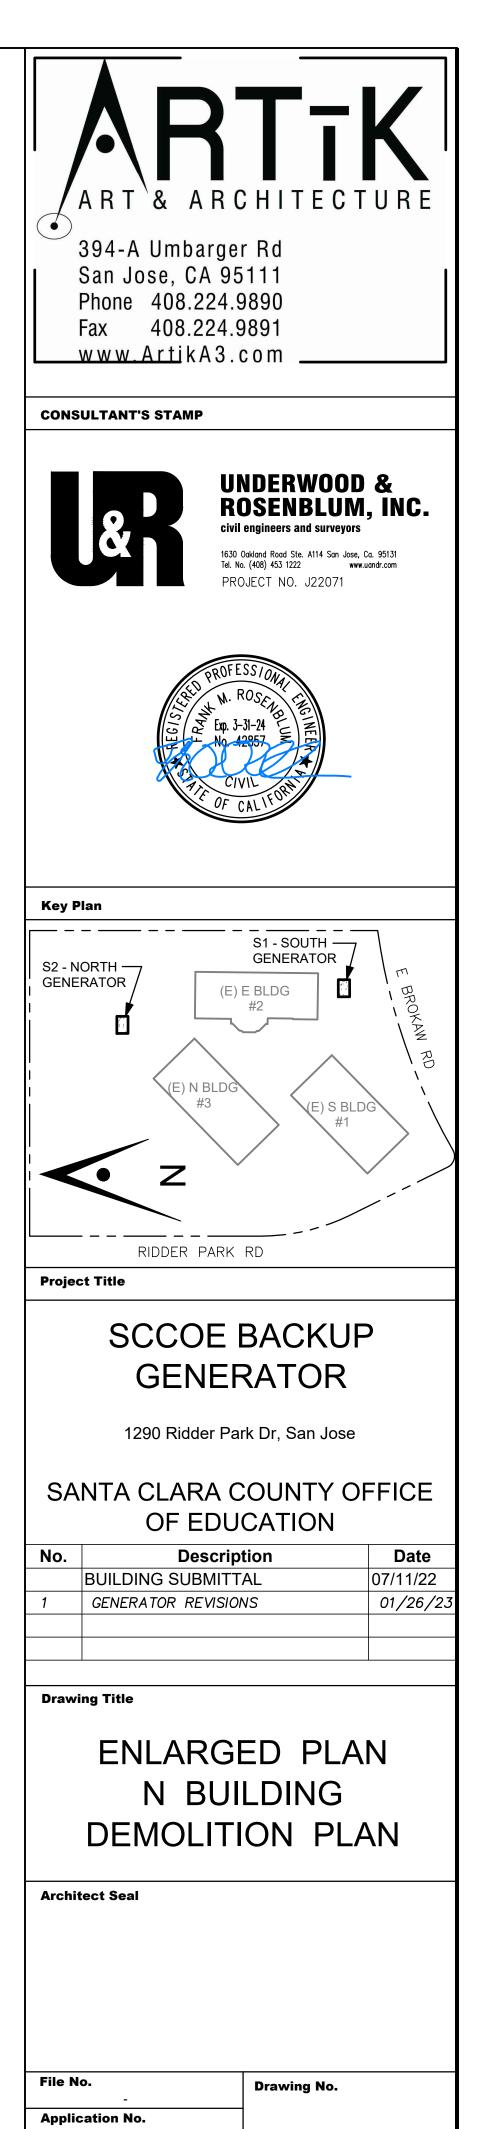
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DEMOLITION LEGEND

- REMOVE EXISTING PAVEMENT/CONCRETE
- GRIND & 3" AC OVERLAY
- REMOVE EXISTING TREE
- XXX XXX REMOVE EXISTING CURB/GUTTER
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 - REMOVE EXISTING UNDERGROUND UTILITY
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 - SAW CUT LINE ASPHALT CONCRETE
 - AREA DRAIN
 - CATCH BASIN CLEAN OUT
 - CONCRETE
 - EXISTING
 - SEE ARCHITECTURE DRAWING SEE ELECTRICAL DRAWING
 - TYPICAL



C1

Sheet 2 of 6

FOR INFORMATION ONLY NOT REVIEWED OR APPROVED BY PUBLIC WORKS


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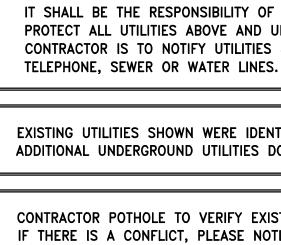
PW Project #

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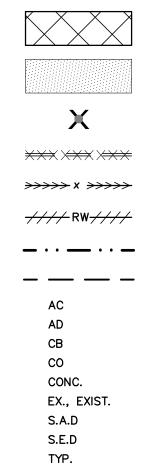






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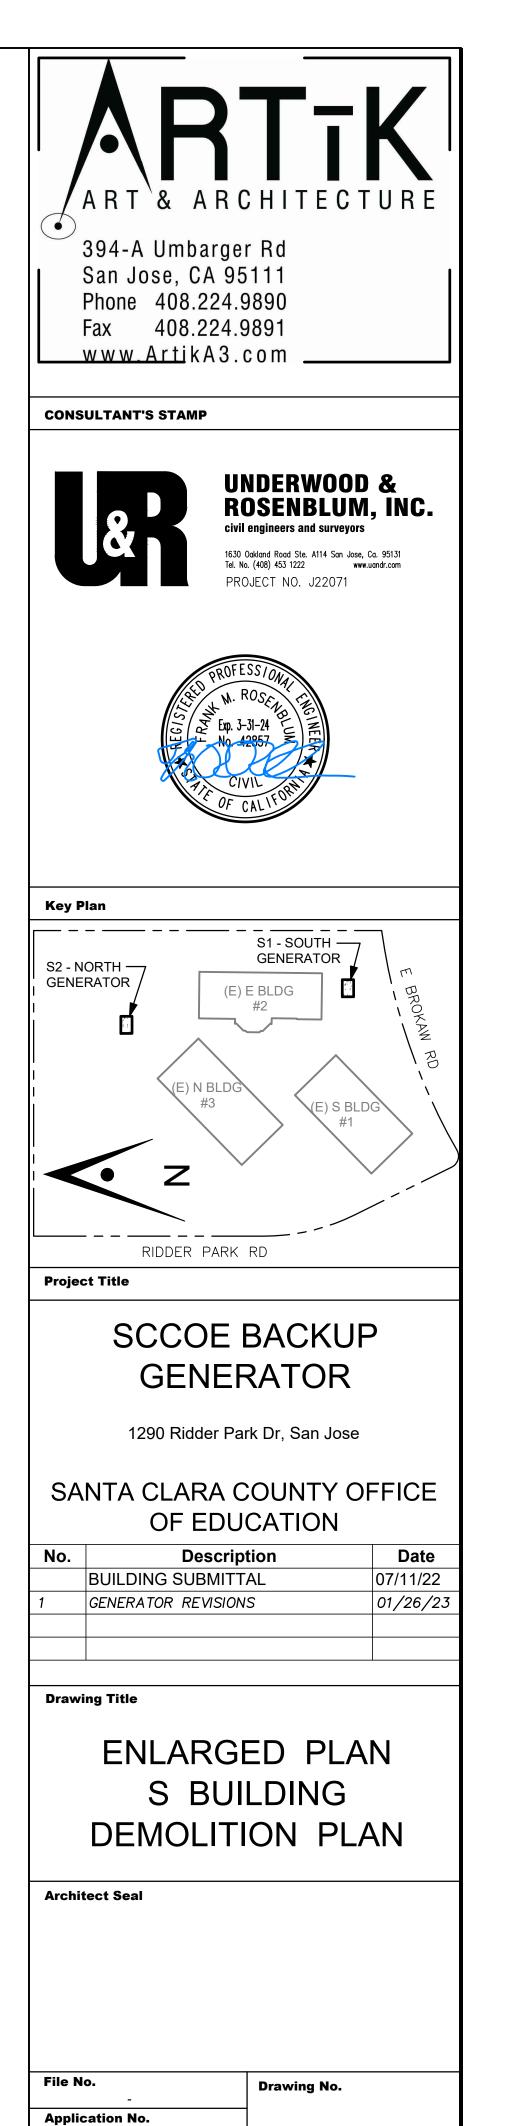
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DEMOLITION LEGEND
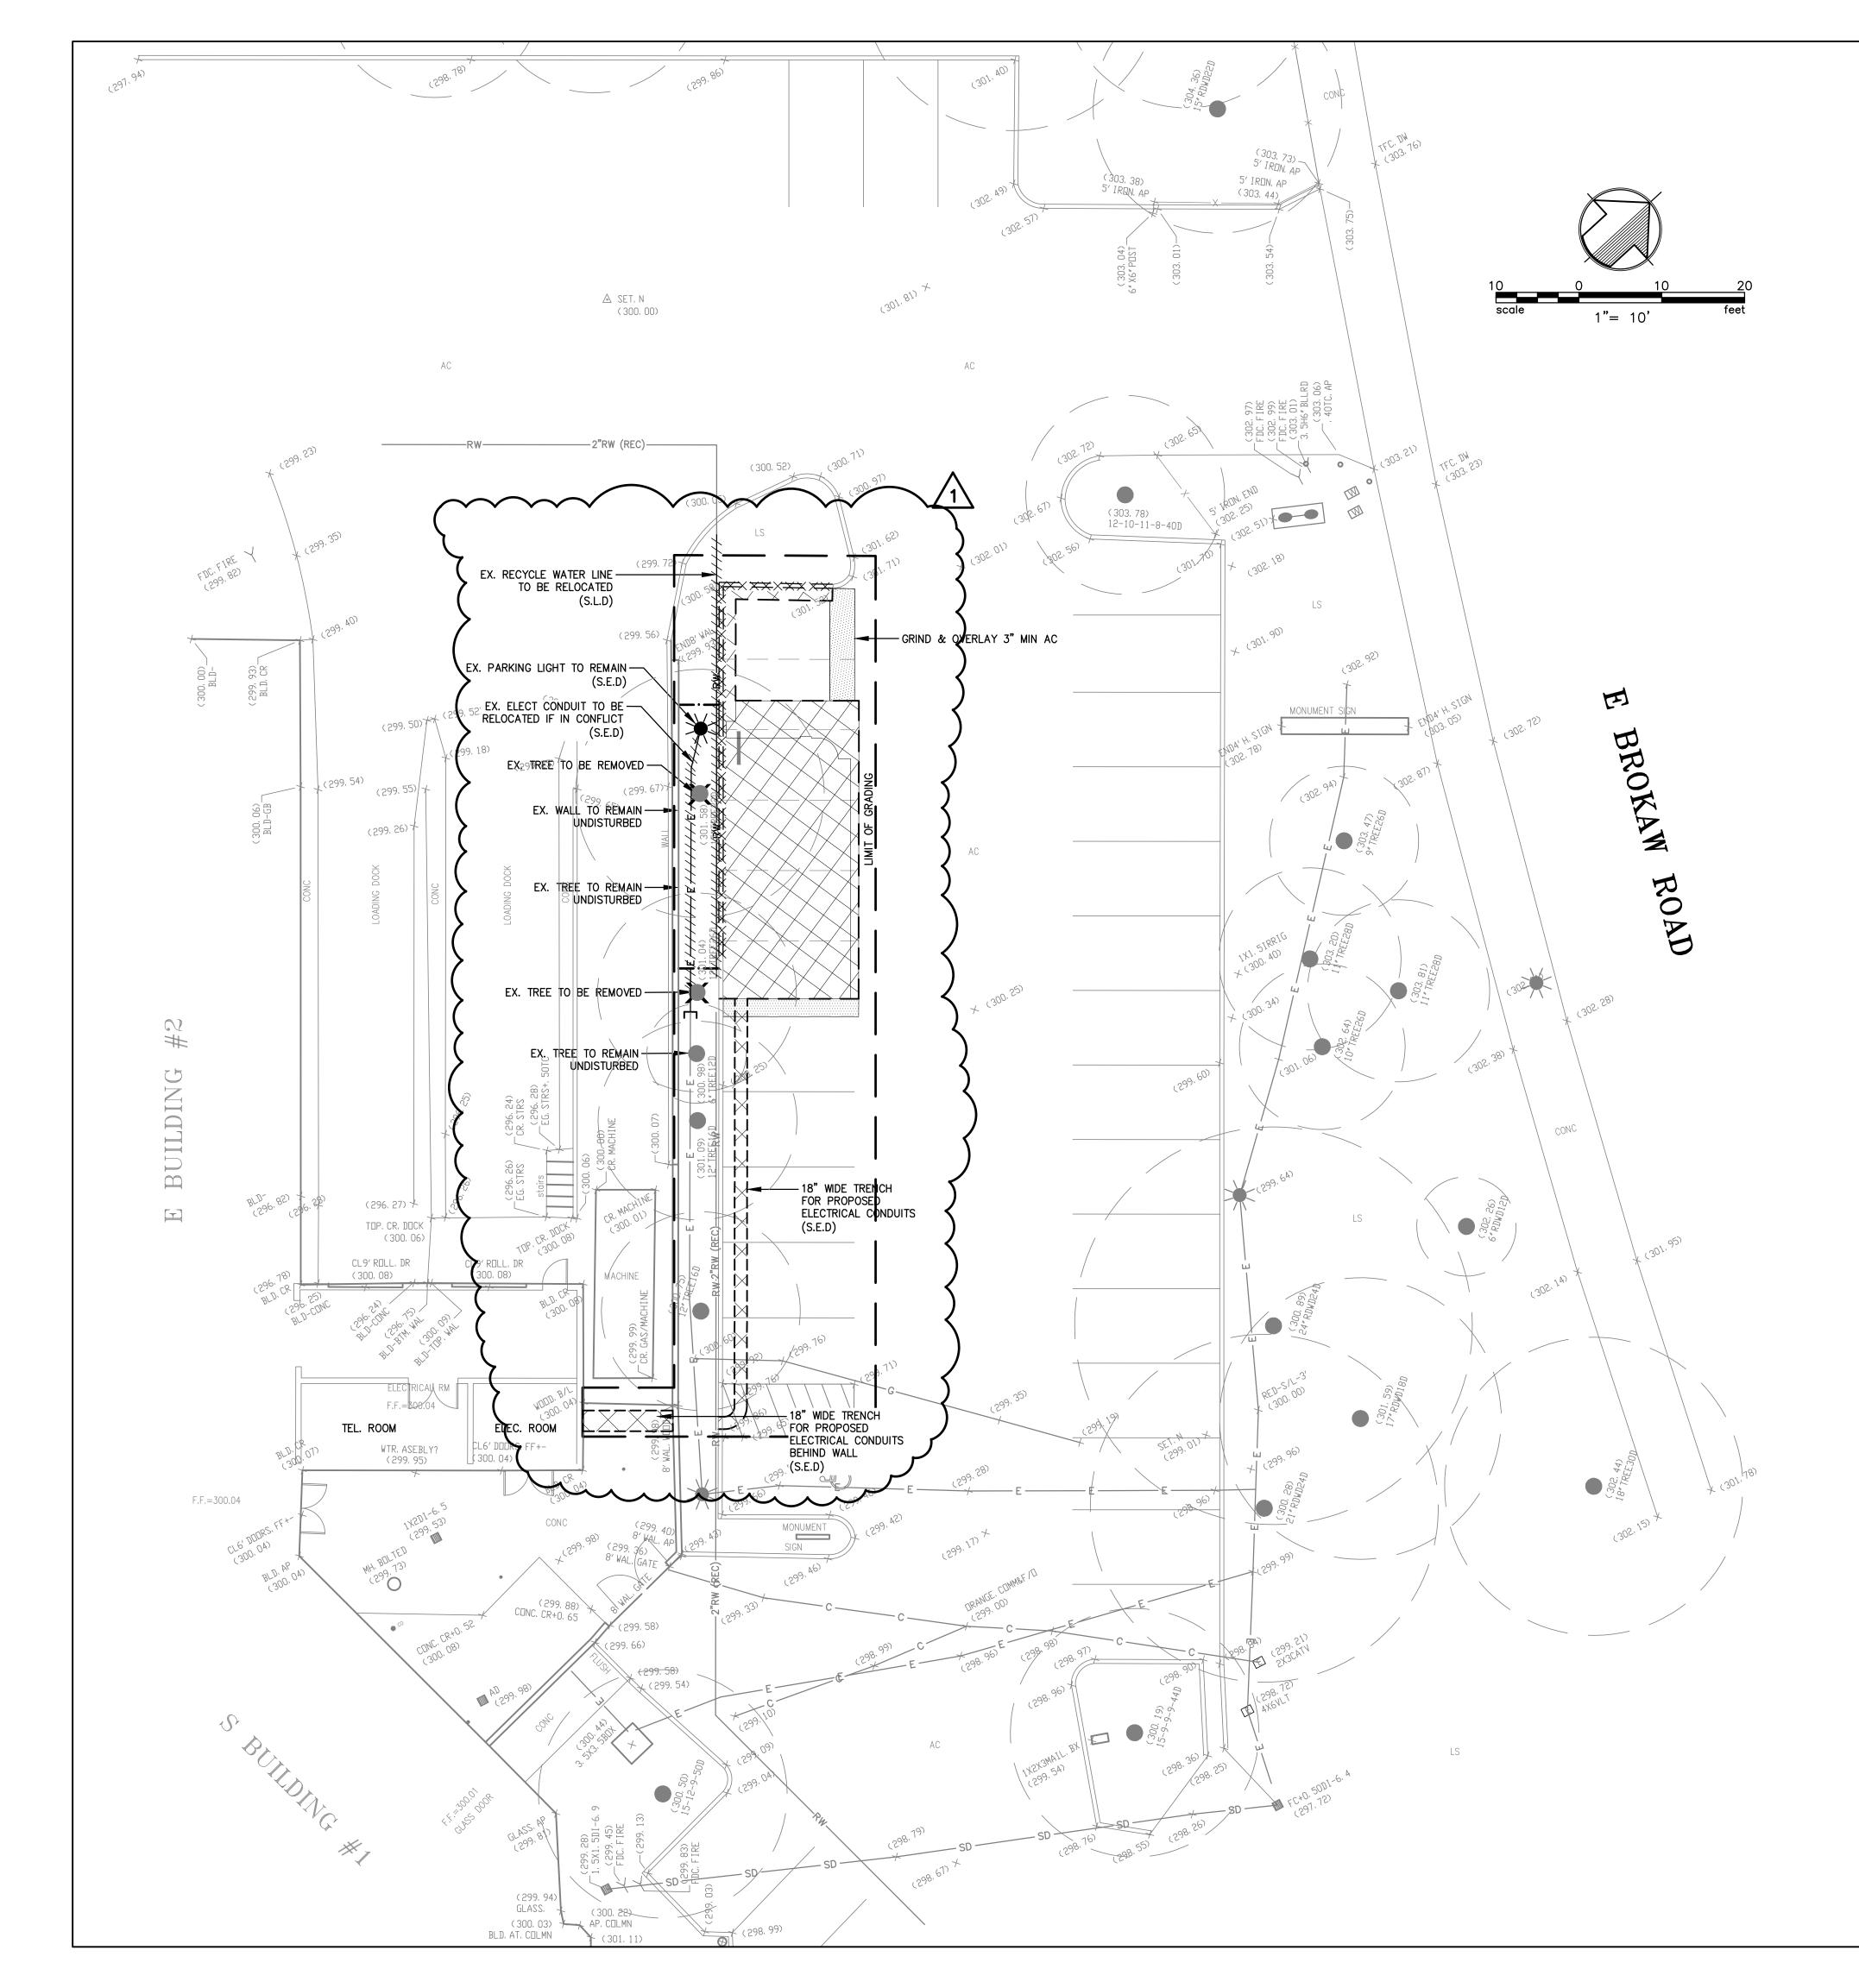
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FOR INFORMATION ONLY NOT REVIEWED OR APPROVED BY PUBLIC WORKS

Date

Project Number


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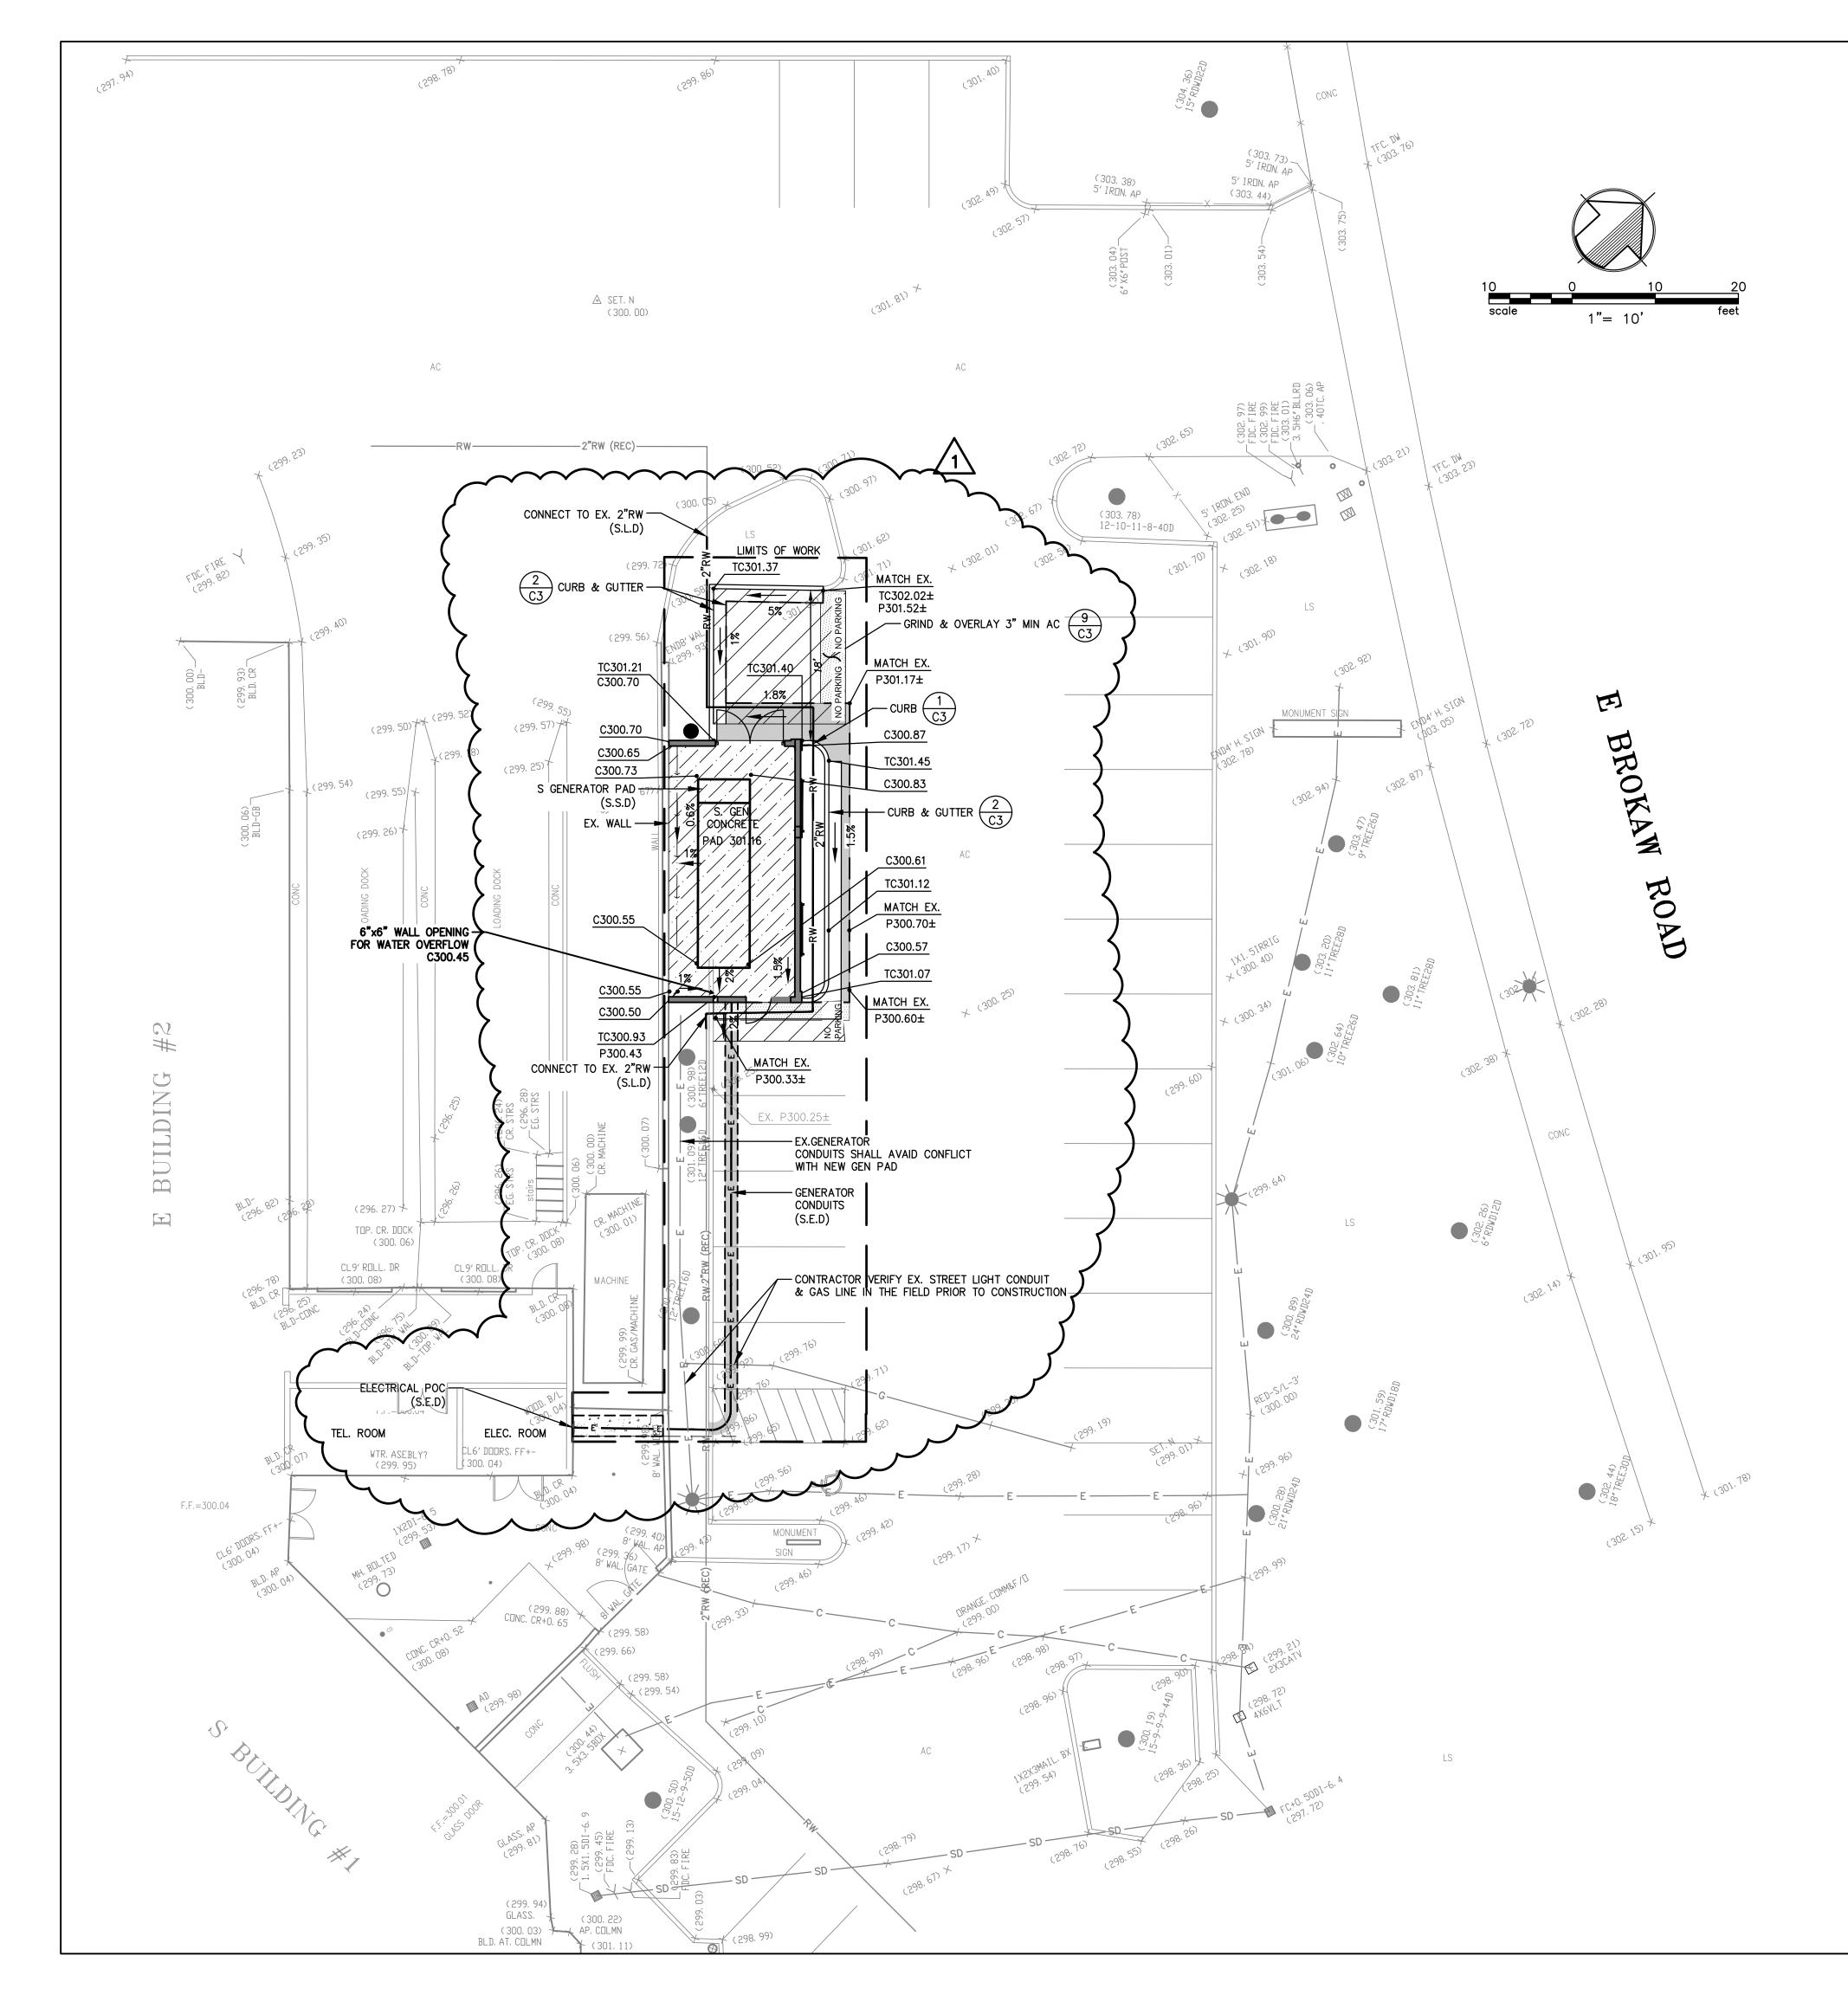
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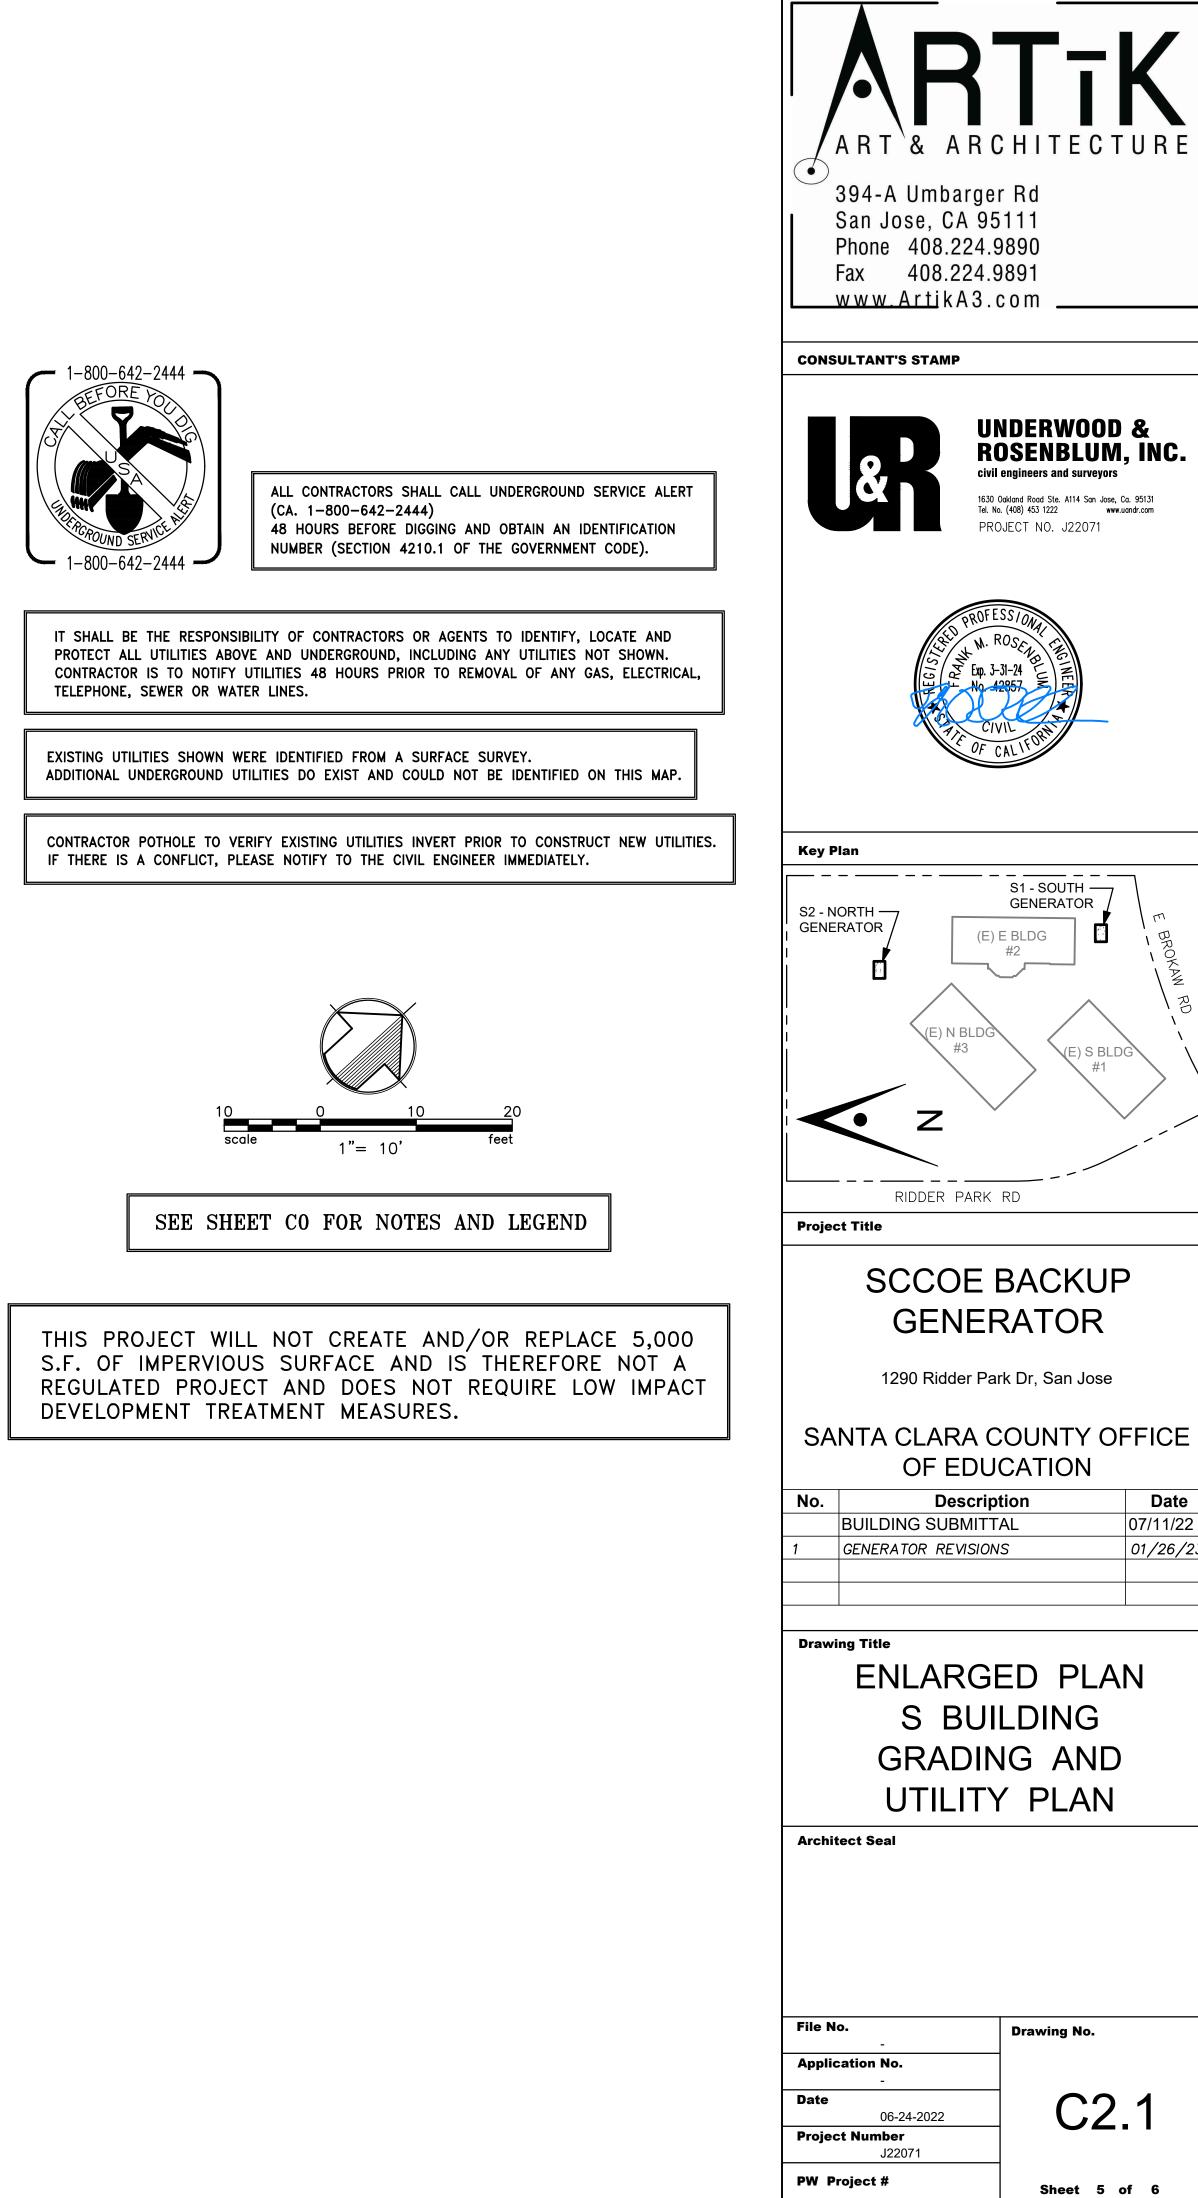
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Sheet 3 of 6









E) S BLDG

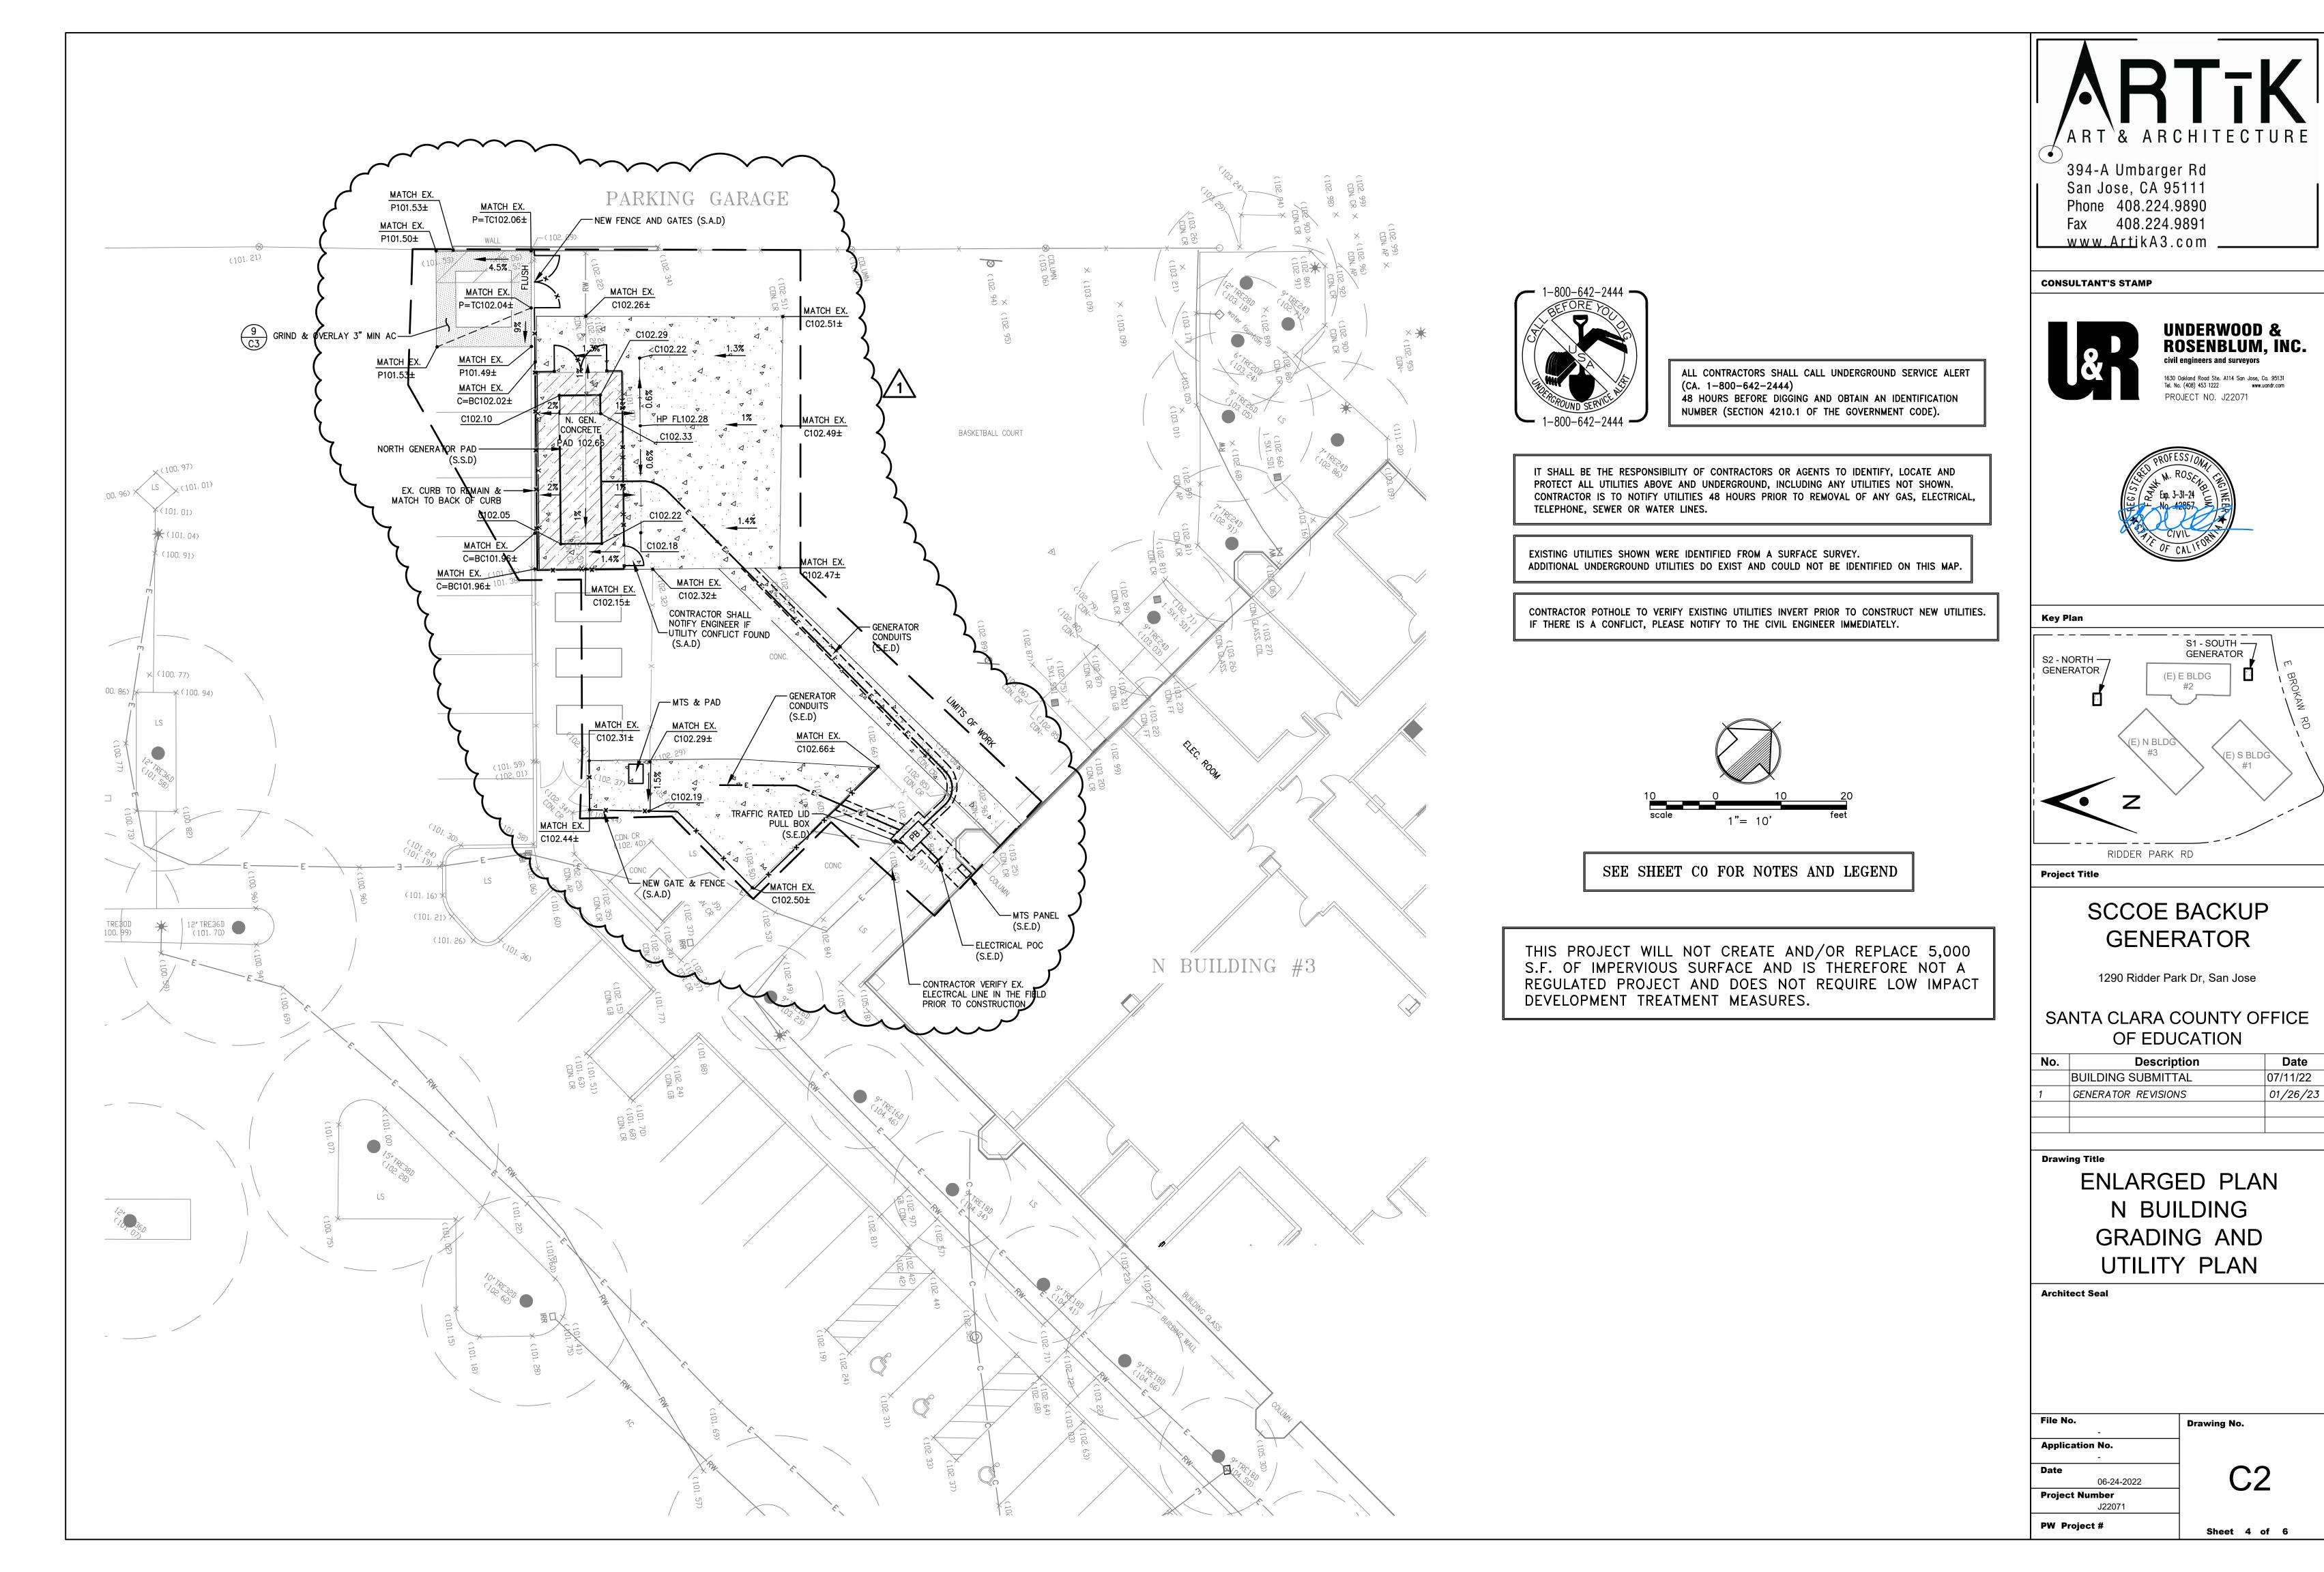Date 07/11/22

01/26/23

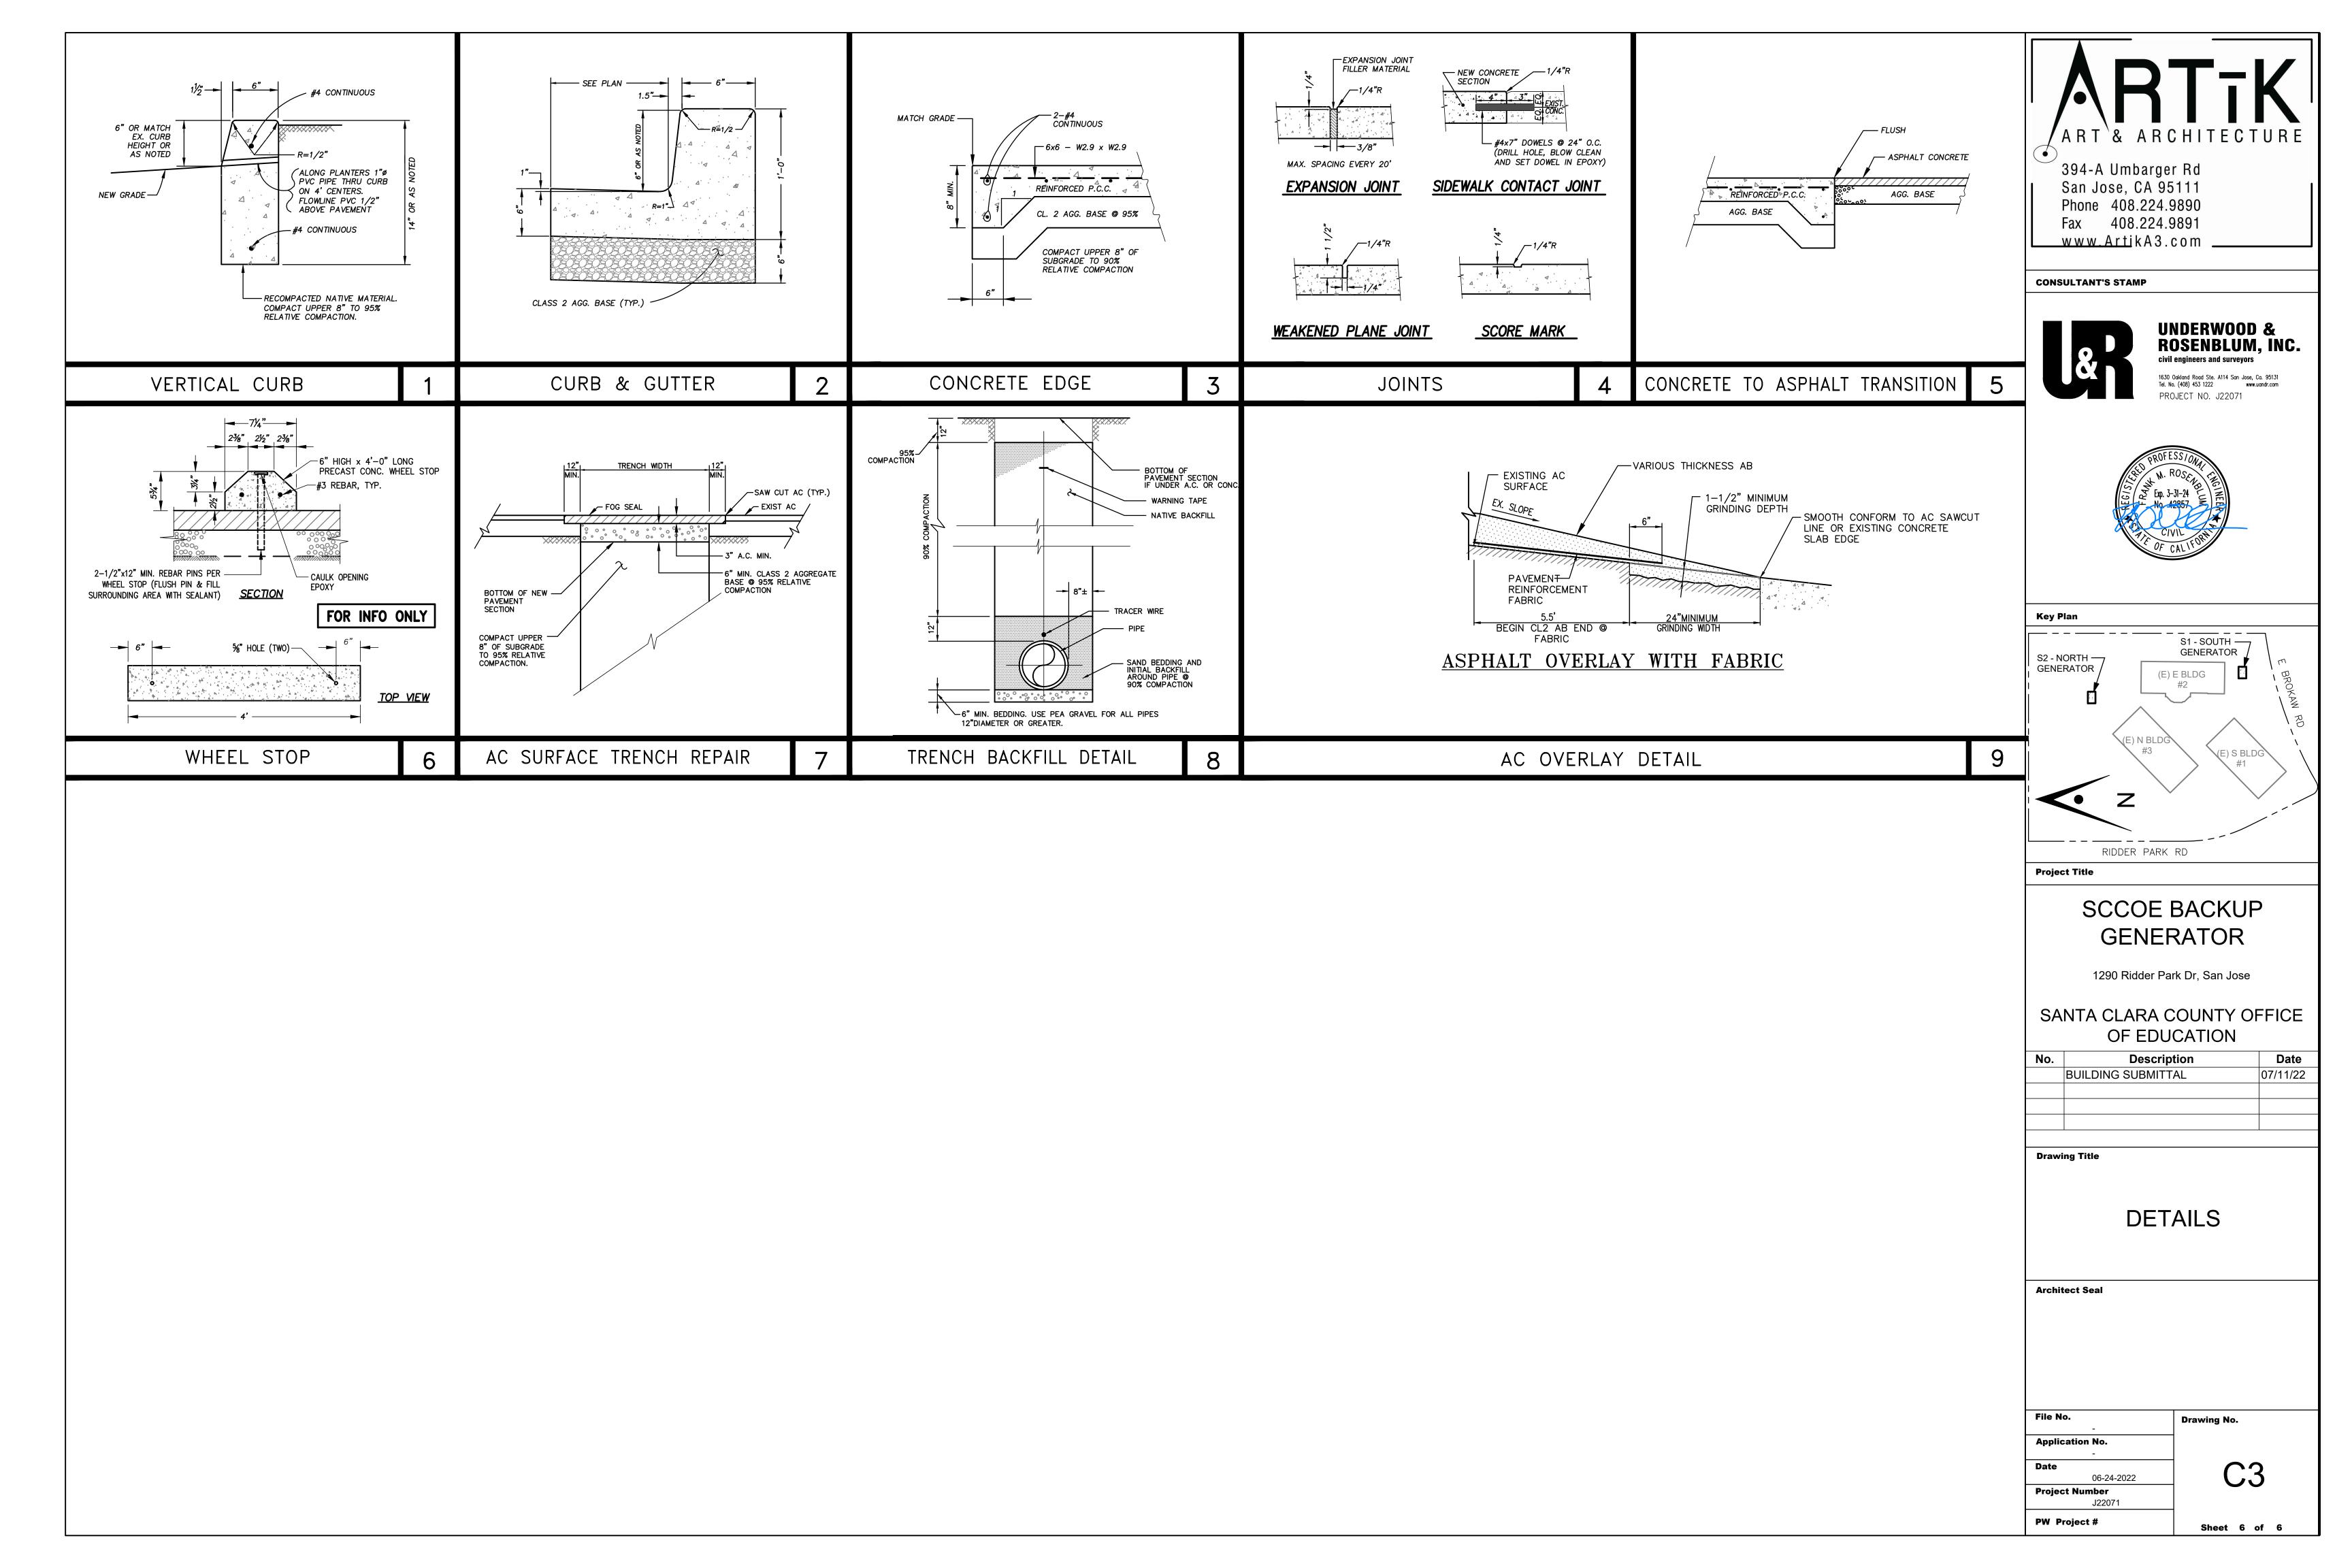

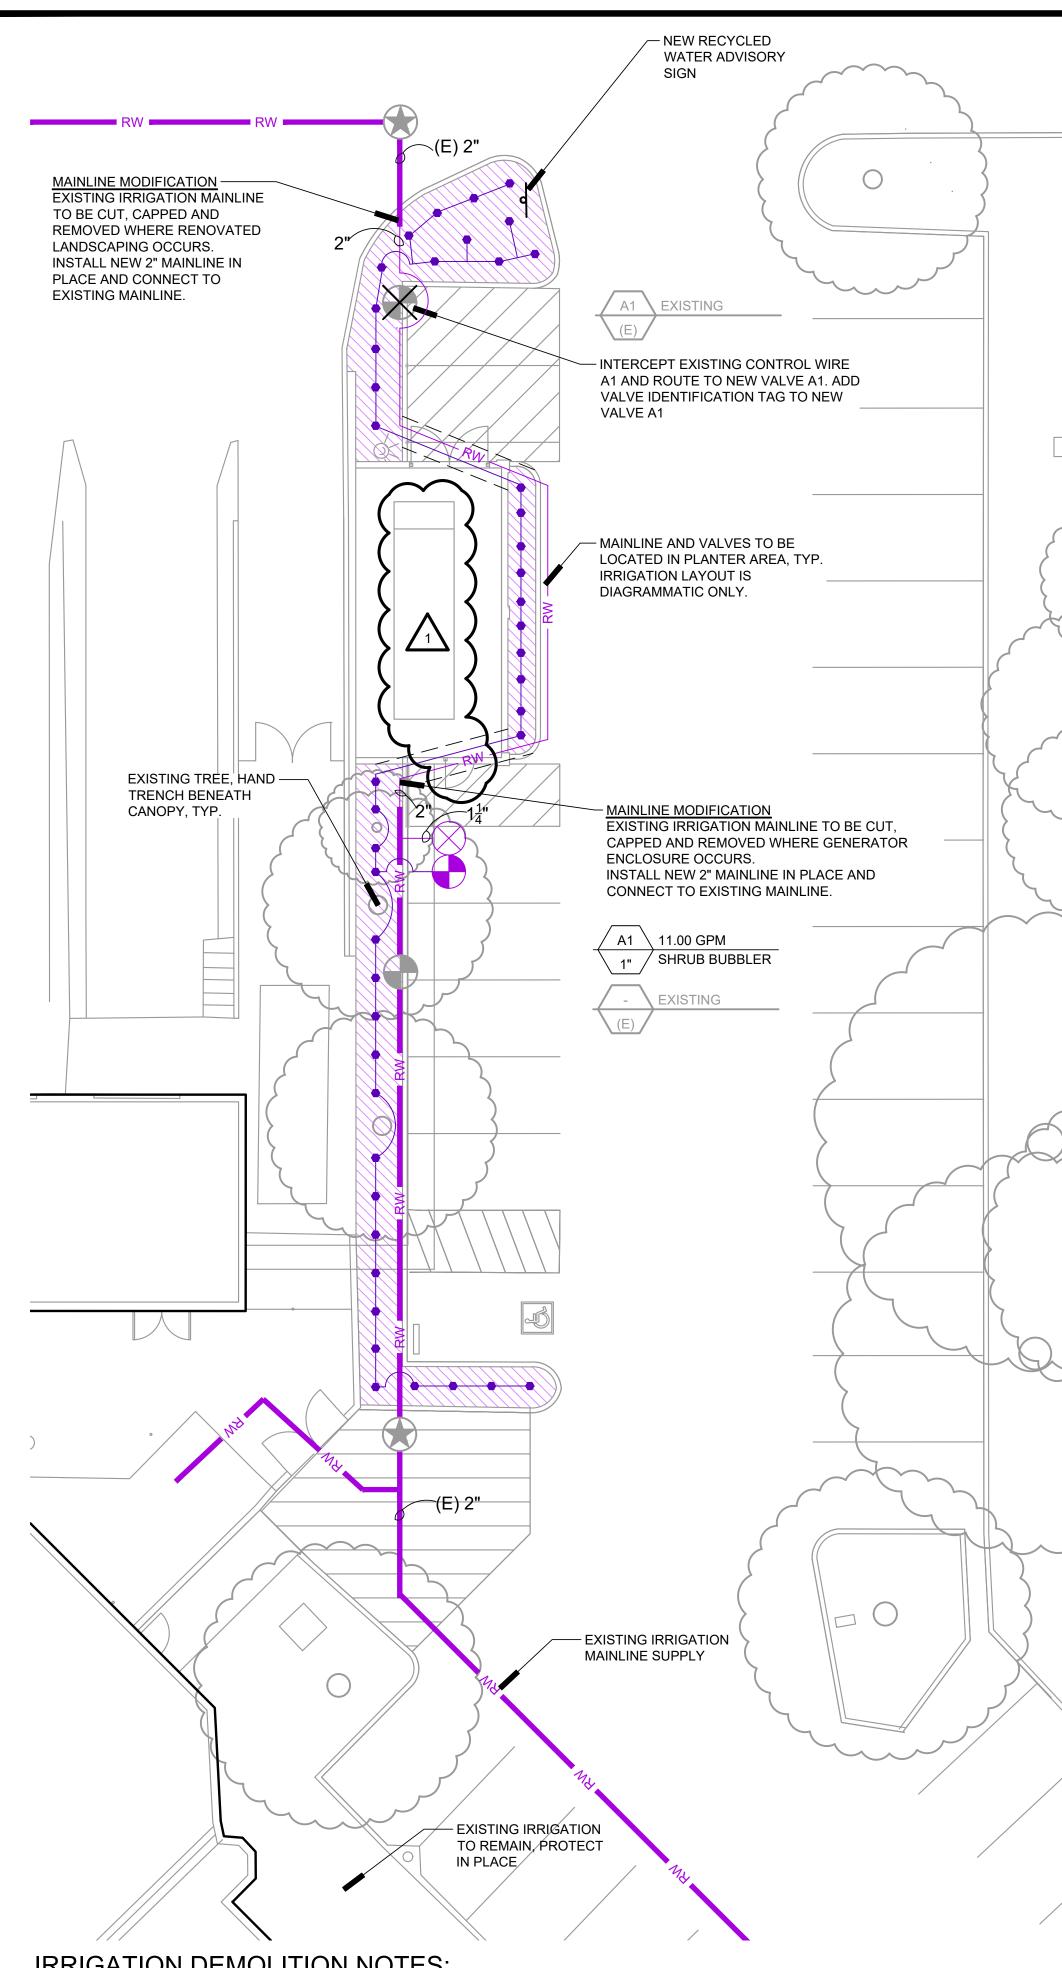

IRRIGATION DEMOLITION NOTES:

CONTRACTOR SHALL EXECUTE IRRIGATION WORK EXPEDITIOUSLY TO MAINTAIN WATER SERVICE FOR EXISTING TO REMAIN IRRIGATION SYSTEMS OF PROJECT AREA AS REQUIRED TO MAINTAIN PLANT MATERIAL IN A HEALTHY CONDITION.

CONTRACTOR SHALL SCHEDULE OR PHASE WORK AS APPROPRIATE WITH GENERAL CONTRACTOR'S OVER-ALL PROJECT SCHEDULING.

IRRIGATION CONTRACTOR SHALL INCLUDE IN THEIR BID TO COORDINATE WITH GENERAL CONTRACTOR PRIOR TO DEMOLITION AND GRADING AND MAKE TEMPORARY AND PERMANENT CONNECTIONS AND / OR REPAIRS AS NECESSARY TO MAINTAIN IRRIGATION WATER SERVICE TO IRRIGATION SYSTEMS LOCATED OUTSIDE OF PROJECT AREA AFFECTED BY CONSTRUCTION. CONTRACTOR TO MAINTAIN WATER SUPPLY TO PLANTS AND TURF AT ALL TIMES OR SUPPLY WATER MANUALLY TO MAINTAIN PLANTS AND TURF IN HEALTHY CONDITION THROUGHOUT CONSTRUCTION. DAMAGE TO TURF DUE TO INSUFFICIENT WATER SHALL BE REPAIRED BY INSTALLING NEW SOD.

4. CONTRACTOR SHALL NOTIFY AND COORDINATE WITH SITE LANDSCAPE SUPERVISOR IN ADVANCE OF PLANNED DISRUPTIONS OF IRRIGATION WATER SERVICE.

IRRIGATION NOTES

- 1. THESE NOTES ARE FOR GENERAL REFERENCE IN CONJUNCTION WITH AND AS A SUPPLEMENT TO THE WRITTEN SPECIFICATIONS, DETAILS, ADDENDA AND CHANGE ORDERS ASSOCIATED WITH THE CONTRACT DOCUMENTS.
- (USA) AT (800) 642-2444 PRIOR TO BEGINNING WORK. CONTACT OWNER'S REPRESENTATIVE SHOULD ANY CONFLICTS ARISE.
- 3. THE IRRIGATION SYSTEM SHALL BE INSTALLED IN ACCORDANCE WITH LOCAL CODES AND REGULATIONS. CONTRACTOR TO CONFORM TO THE REQUIREMENTS OF NFPA 24, SECTION 8.1, MINIMUM 'DEPTH-OF-COVER' (36 INCHES) FOR PIPE TO INCLUDE FIRE LANE ROUTES OF ACCESS.
- 4. THIS SYSTEM IS DESIGNED TO OPERATE AT 60 PSI AND 11.00 GPM FROM THE POINT OF CONNECTION. CONTRACTOR SHALL VERIFY PRESSURE AND FLOW PRIOR TO BEGINNING OF WORK. CONTACT OWNER'S REPRESENTATIVE IMMEDIATELY SHOULD CONFLICTS ARISE.
- 5. THE IRRIGATION SYSTEM DESIGN IS DIAGRAMMATIC. WHERE PIPING, VALVES, ETC. ARE SHOWN OUTSIDE OF PLANTING AREAS, THE INTENT IS FOR PIPING, VALVES, ETC. TO BE INSTALLED WITHIN PLANTING AREAS UNLESS OTHERWISE NOTED AND DETAILED.
- 6. CONTRACTOR SHALL COORDINATE IRRIGATION INSTALLATION WITH OTHER TRADES. CONTRACTOR TO COORDINATE AND VERIFY ALL SLEEVING, PIPING, ELECTRICAL SUPPLY, POINT OF CONNECTION, ETC.
- 7. CONTRACTOR IS RESPONSIBLE FOR COMPLETE AND UNIFORM COVERAGE OF PLANTING AND TURF AREAS. CONTRACTOR TO THROTTLE THE FLOW CONTROL AT EACH VALVE TO OBTAIN OPTIMUM OPERATING PRESSURE FOR EACH CIRCUIT. ADJUST SPRAY HEADS AND NOZZLES FOR OPTIMUM COVERAGE WHILE PREVENTING OVERSPRAY ONTO WALKWAYS AND STRUCTURES. ADDITIONALLY, CONTRACTOR SHALL ADJUST ALL VALVES, NOZZLES, AND HEADS FOR OPTIMUM COVERAGE, AVOIDING MISTING, OVERSPRAY, OR UNDERSPRAY.
- 8. LATERAL LINES TO BE SIZED PER PIPE SIZING CHART.
- 9. CONTRACTOR TO MAINTAIN AS-BUILT DRAWING SET TO BE AVAILABLE ON SITE AT ALL TIMES AND AT TIME OF SUBSTANTIAL COMPLETION REVIEW. CONTRACTOR SHALL PREPARE REDUCED, COLOR-CODED PLANS, LAMINATE, AND PLACE (1) IN CONTROLLER ENCLOSURE AND DELIVER (1) TO OWNER'S REPRESENTATIVE AFTER APPROVAL OF RECORD DRAWING SUBMITTAL AND PRIOR TO FINAL COMPLETION.
- 10. CONTRACTOR SHALL EXERCISE EXTREME CAUTION WHEN TRENCHING AROUND EXISTING TREES AND SHRUBS. CONTRACTOR SHALL HAND TRENCH WHEN TRENCHING ACROSS ROOTS 2" AND LARGER TO PRESERVE ROOT SYSTEM. ROOTS SMALLER THAN 2" MAY BE TRIMMED. DO NOT TEAR ANY ROOTS.
- 11. THE CONTRACTOR SHALL BE RESPONSIBLE UNDER THIS CONTRACT FOR REPAIRING OR REPLACING, AT THEIR OWN EXPENSE, ANY STRUCTURES, FENCES, WALLS, PLANT MATERIAL OR TREES DAMAGED OR DESTROYED, BOTH ON THIS PROPERTY OR THOSE PROPERTIES ADJACENT TO THIS SITE. THE DAMAGED ITEM(S) WILL BE RESTORED TO THEIR ORIGINAL CONDITION OR REPLACED TO THE SATISFACTION OF THE OWNER'S REPRESENTATIVE.
- 12. EXISTING IRRIGATION CONTROLLER IS LOCATED ON THE EAST SIDE OF BUILDING IN UTILITY YARD.
- 13. REFER TO SPECIFICATIONS SECTION AND IRRIGATIONS DETAILS ON SHEETS L1.2 AND L1.3. TEMPORARY TREE AND PLANT PROTECTION 015639 328400 PLANTING IRRIGATION

IRRIGATION LEGEND

SYM	MODEL	MANUF.	DESCRIPTION
_ _	-	-	RECYCLED WATER ADVISORY
BUBB	BLERS		
	1401	RAINBIRD	FLOOD BUBBLER - ONE PER SH
VALV	ES		
	-	-	EXISTING REMOTE CONTROL V
\mathbf{X}	-	-	EXISTING REMOTE CONTROL V
	-	-	EXISTING QUICK COUPLING VA
\bigotimes	-	AQUA	1/4"-2" BRONZE BODY BALL VAL
	PESBR-PRS-D	RAINBIRD	ELECTRIC PRESSURE COMPEN PLAN. AN ASTERISK (*) DENOTE VALVE FOR FLOWS LESS THAN
PIPIN		ł	·
	RW RW		EXISTING IRRIGATION MAINLIN SIZE AND LOCATION
	RW RW	/	SCH 40 (UP TO 1-1/2") CLASS 31 PURPLE COLOR, NSF APPROVE PLANTING AREAS AND 36" BEL
			SCHEDULE 40 PVC NON-PRESS DEPTH TO BE 18". NSF APPROV
			SCH 40 PVC SLEEVES, (2) IN EA 3" MIN. IN SIZE, 36" MINIMUM DI
			•

SOUTH BAY RECYCLED WATER USE ZONES:

BUBBLER IRRIGATION

SEE SHEET L1.3 FOR SOUTH BAY WATER RECYCLING STANDARD NOTES AND DETAILS

LOCATED OUTSIDE	


LATERAL PIPE SIZE CHART, SCH 40 PVC

GALLONS PER MINUTE	PIPE S
0 - 7 GPM	3/4"
7.01 - 12 GPM	1"
12.01 - 22 GPM	1-1/4"
22.01 - 30 GPM	1-1/2"
30.01 - 50 GPM	2"
50.01 - 70 GPM	2-1/2"
70.01 - 110 GPM	3"

C = GALLONS PER MINUTE A = VALVE NUMBE

B = VALVE SIZE D = DESCRIPTION -

IZE

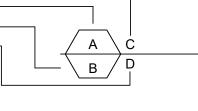

DDW ACCEPTANCE SIGNATURES FOR SBWR PROJECT ID SWC0159AP--FOR APPROVAL DATE: File Number Drawing No Application Number SBWR - SOUTH BAY WATER RECYCLING DATE: Date SCALE: 1" = 10'-0" 02.07.2023 Project No. 06401 ANLA: 2210

2. CONTRACTOR SHALL BECOME FAMILIAR WITH THE LOCATION OF EXISTING AND PROPOSED UNDERGROUND SERVICES. CONTACT UNDERGROUND SERVICE ALERT

	GPM	PSI	RAD
SIGN, DETAIL RW-36, L3.3	0.25	30	-
HRUB, PER DETAIL	0.25	30	-
ALVE TO REMAIN			
VALVE TO BE REMOVED			
ALVE			
LVE, LINE SIZE			
NSATING REMOTE CONTROL VA ES TO INSTALL A "Y" FILTER UF N 5.0 GPM.			
IE TO REMAIN, CONTRACTOR T	O FIELI	D-VER	lFY
15 (2" TO 4") PVC PRESSURIZED ED, SIZE PER PLAN, DEPTH TO			

OW PAVED AREAS. SURIZED LATERAL LINE, PURPLE COLOR,

VED, SIZE PER CHART

ACH LOCATION, SIZE AS REQUIRED, DEPTH



San Jose, CA 95111 Phone 408.224.9890 Fax 408.224.9891 www.ArtikA3.com

Consultant





1213 Lincoln Ave, Suite 211 San Jose, CA 95125 T. 408.292.2196 www.anla-associates.com

Key Plan

Project Title

SCCOE BACKUP GENERATOR


1290 Ridder Park Dr, San Jose

SANTA CLARA COUNTY OFFICE OF EDUCATION No. Description Date 1 BUILDING SUBMITTAL 07/11/2022 **BUILDING RE-SUBMITTAL** 02/07/2023

Drawing Title

IRRIGATION PLAN

Architect Seal

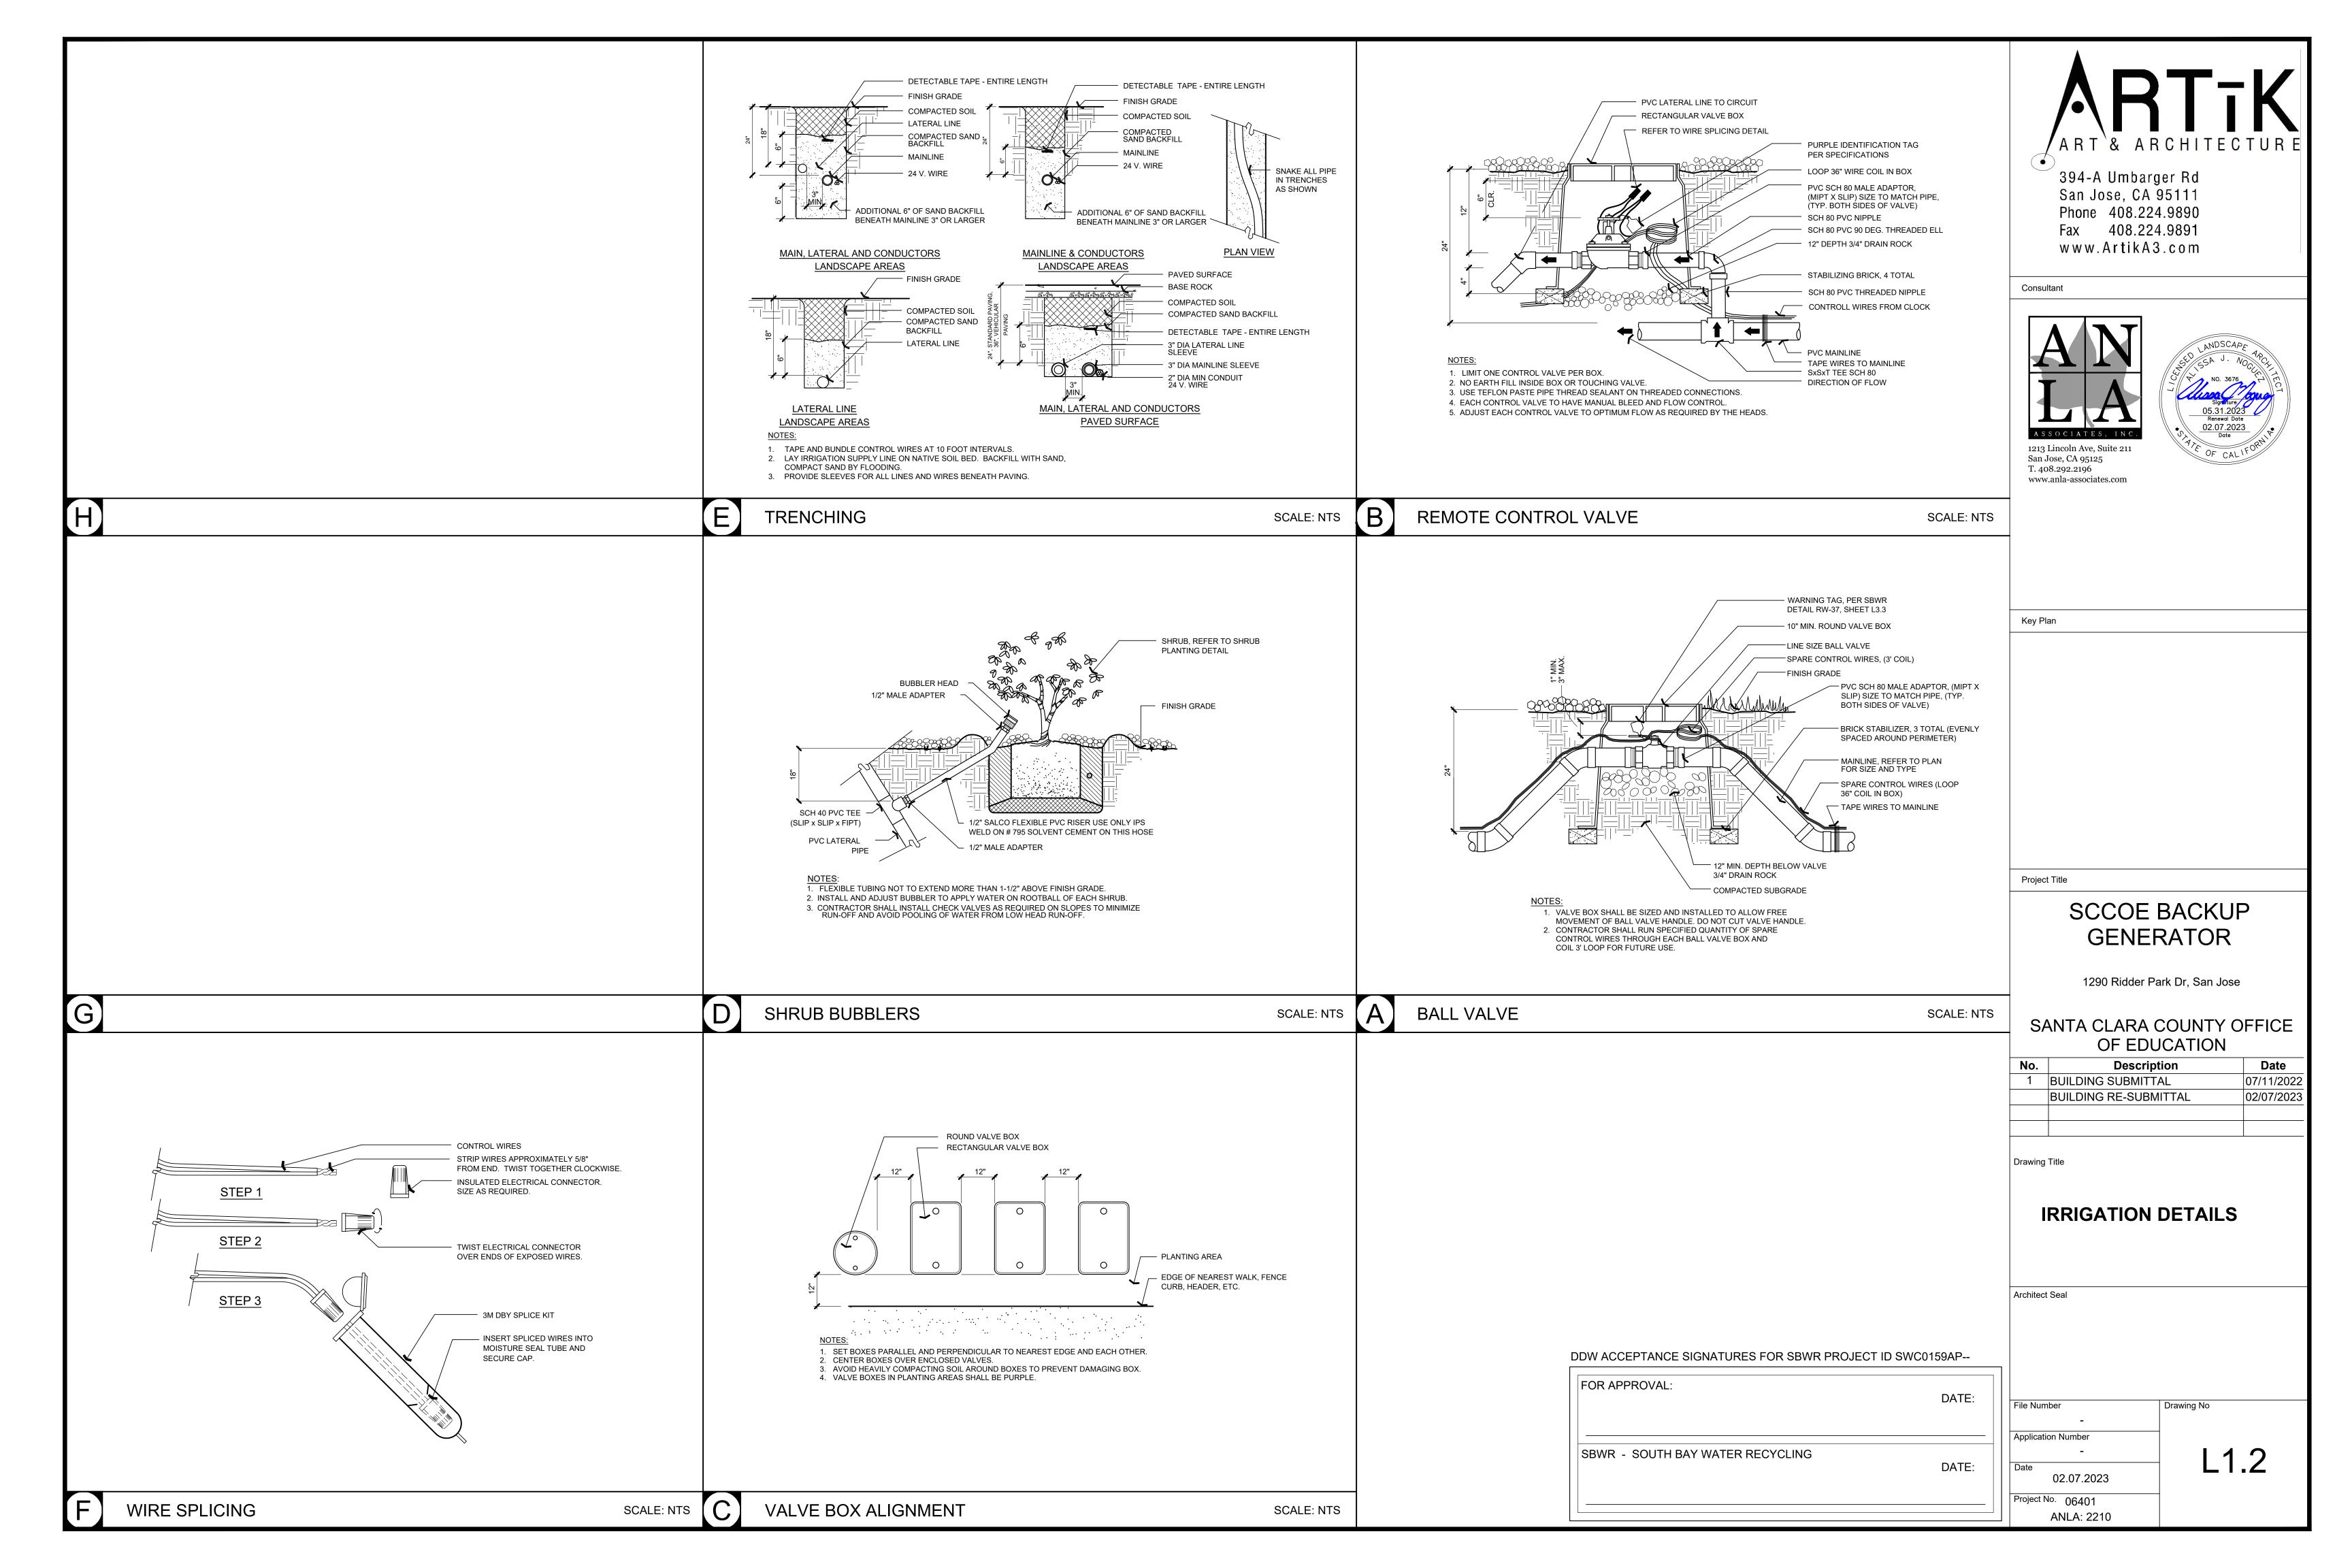



SOUTH BAY WATER RECYCLING (SBWR) STANDARD NOTES FOR **RECYCLED WATER SYSTEMS:**


- 1. PRIOR TO RECEIVING RECYCLED WATER, THE SITE MUST BE PERMITTED BY SOUTH BAY WATER RECYCLING (SBWR). A PERMIT WILL BE GRANTED AFTER: A. INSPECTION BY SBWR HAS BEEN COMPLETED SHOWING CONFORMANCE WITH SBWR RULES AND
 - REGULATIONS (https://www.sanjoseca.gov/home/showdocument?id=526); B. A FINAL ON-SITE INSPECTION HAS BEEN CONDUCTED TO CONFIRM THAT ALL REQUIREMENTS HAVE BEEN MET;
 - C. THE CUSTOMER HAS PROVIDED THE SBWR INSPECTOR WITH THE MOST CURRENT BACKFLOW PREVENTION DEVICE TEST REPORTS FOR ALL OF THE SITE'S POTABLE WATER AND FIRE SERVICE CONNECTIONS (AND ANY AUXILIARY WATER SOURCES). D. SITE HAS PASSED REQUIRED CROSS-CONNECTION TEST PERFORMED BY A CERTIFIED AWWA CROSS-CONNECTION SPECIALIST;


THE OWNER'S OR TENANT'S REPRESENTATIVE MUST ALSO COMPLETE A SITE SUPERVISOR TRAINING CLASS OFFERED BY SBWR IN ORDER TO RECEIVE A PERMANENT PERMIT. IN THE INTERIM BETWEEN CONNECTION AND TRAINING, THE TENANT OR OWNER WILL RECEIVE A TEMPORARY RECYCLED WATER PERMIT. CONTACT SBWR AT (408) 277-3671 FOR FURTHER INFORMATION.

- 2. ALL WORK SHALL CONFORM TO EXISTING REGULATIONS INCLUDING BUT NOT LIMITED TO: SOUTH BAY WATER RECYCLING (SBWR) RULES AND REGULATIONS
- B. STATE WATER RESOURCES CONTROL BOARD DIVISION OF DRINKING WATER REGULATIONS
- CHANGES MADE TO THE APPROVED IRRIGATION PLANS SHALL BE SUBMITTED TO SBWR FOR REVIEW AND APPROVAL AT LEAST 2 WEEKS PRIOR TO START OF CONSTRUCTION.
- 4. AT LEAST TWO DAYS PRIOR TO START OF CONSTRUCTION, CONTRACTOR AND SBWR INSPECTOR SHALL HOLD A PRE-CONSTRUCTION MEETING. TO SCHEDULE MEETING, CONTACT SBWR AT (408) 277-3671.
- 5. NOTIFY SBWR INSPECTOR A MINIMUM OF AT LEAST 24 HRS BEFORE WORK BEGINS. SBWR INSPECTOR MUST INSPECT AND/OR VERIFY:
 - PRESENCE OF PROPER BACKFLOW PREVENTION AT ALL POTABLE POINTS OF CONNECTION; NEW UNDERGROUND PIPING (LABELING, CLEARANCES, BURIAL DEPTH, SLEEVING); INSTALLATION OF SIGNS, TAGS, AND CONTROLLER DECALS;
 - REQUIRED TEMPORARY CONNECTION TO POTABLE WATER SERVICE; IN MOST CASES, THE SITE'S IRRIGATION SYSTEM MUST BE CONNECTED TO A TEMPORARY SOURCE OF POTABLE WATER IN ORDER TO CONDUCT REQUIRED CROSS-CONNECTION TEST; E. SITE PASSED REQUIRED CROSS-CONNECTION TEST PERFORMED BY A CERTIFIED AWWA CROSS-
 - CONNECTION SPECIALIST; F. NEW METER INSTALLATION – PRIOR TO RECEIVING RECYCLED WATER, SBWR INSPECTOR MUST INSPECT THE DISCONNECTION OF THE SITE'S IRRIGATION SYSTEM FROM THE TEMPORARY POTABLE WATER SUPPLY, AND THEN INSPECT THE CONNECTION OF THE SYSTEM TO THE RECYCLED WATER METER.
- 6. NO CROSS-CONNECTIONS BETWEEN THE POTABLE AND RECYCLED WATER SYSTEMS ARE PERMITTED.
- 7. ALL ON-SITE BURIED RECYCLED WATER PIPING SHALL BE IDENTIFIED BY ONE OF THE FOLLOWING METHODS: USING PURPLE-COLORED PVC PIPE WITH CONTINUOUS WORDING: "CAUTION – RECYCLED WATER" PRINTED ON OPPOSITE SIDES OF THE PIPE; PIPE SHALL BE LAID WITH WORDING FACING UPWARDS;
 - B. WARNING TAPE WITH A MINIMUM WIDTH OF 3 INCHES READING: "CAUTION RECYCLED WATER" (IN BLACK OR WHITE LETTERING ON PURPLE BACKGROUND) SHALL RUN CONTINUOUSLY ON TOP OF
 - PIPING AND SHALL BE ATTACHED TO PIPING WITH PLASTIC TAPE BANDED AROUND THE WARNING TAPE AND THE PIPE EVERY 5 FEET ON CENTER: C. BLUE-COLORED PVC PIPE SHALL NOT BE USED UNLESS THE BLUE COLOR IS COMPLETELY OBSCURED BY ENCASEMENT OF THE PIPE WITH PURPLE POLYETHYLENE WRAP OR OTHER METHODS APPROVED BY SBWR.
- 8. PVC PIPE: CONSTANT-PRESSURE MAINLINE PIPING 1 1/2 INCHES AND SMALLER SHALL BE SCHEDULE 40; CONSTANT-PRESSURE MAINLINE PIPING 2 INCHES AND LARGER SHALL BE CLASS 315 OR C900 CLASS 200 DR 14: INTERMITTENT-PRESSURE LATERAL PIPING SHALL BE SCHEDULE 40 OR CLASS 200. BURIED COPPER PIPE SHALL BE TYPE "K".
- 9. ALL ON-SITE RECYCLED WATER PIPING SHALL BE BURIED TO A MINIMUM DEPTH FROM FINISHED GRADE TO TOP OF PIPE (MINIMUM COVER) OF: A. PRESSURIZED LINES 3 INCHES AND LARGER 24 INCHES
 - PRESSURIZED LINES 2 1/2 INCHES AND SMALLER 18 INCHES INTERMITTENT-PRESSURE LINES 12 INCHES
- 10. ALL RECYCLED WATER PIPING OTHER THAN PVC PIPING WITH SOLVENT WELDED JOINTS SHALL BE PROTECTED AGAINST MOVEMENT WITH THRUST BLOCKS OR RESTRAINED JOINTS OR OTHER APPROVED METHOD PER SBWR DETAILS. 11. MAINTAIN A 10-FOOT HORIZONTAL SEPARATION BETWEEN BURIED PRESSURIZED RECYCLED WATER IRRIGATION
- PIPING AND BURIED POTABLE WATER PIPING UNLESS OTHERWISE NOTED. AT PIPE CROSSINGS, BURIED PRESSURIZED RECYCLED WATER IRRIGATION PIPING MUST BE 12 INCHES BELOW POTABLE WATER LINES. PRESSURIZED RECYCLED WATER PIPELINES ARE ALLOWED OVER POTABLE WATER PIPELINES WITH A MINIMUM OF 12 INCHES VERTICAL SEPARATION IF A FULL STANDARD PIPE LENGTH IS CENTERED OVER THE CROSSING, OR THE RECYCLED WATER PIPELINE IS INSTALLED IN A PIPE SLEEVE WHICH EXTENDS A MINIMUM OF 10 FEET ON EITHER SIDE OF THE POTABLE WATER PIPING. INTERMITTENTLY PRESSURIZED IRRIGATION LATERALS MAY BE LOCATED A MINIMUM OF 12 INCHES ABOVE POTABLE WATER PIPELINES WITHOUT SLEEVING.
- 12. ALL RECYCLED WATER SYSTEM REMOTE CONTROL VALVES, ISOLATION VALVES, QUICK COUPLING VALVES, STRAINERS, AND PRESSURE REDUCING VALVES SHALL BE INSTALLED BELOW GRADE IN VALVE BOXES. LIDS SHALL PERMANENTLY READ "RECYCLED WATER." GREEN, BLACK, OR PURPLE-COLORED PLASTIC BOXES AND LIDS, AND CONCRETE BOXES WITH CONCRETE OR METAL LIDS ARE ACCEPTABLE. FOR PLASTIC BOX LIDS, LETTERING SHALL BE IMPRINTED ON LID OR APPLIED USING A NAMEPLATE ATTACHED ONTO THE LID WITH RIVETS, SCREWS, OR BOLTS, FOR CONCRETE LIDS, LETTERING SHALL BE IMPRINTED ON LID FROM FACTORY. FOR CAST IRON AND METAL CHECKER PLATE LIDS, LETTERING MUST BE BEAD-WELDED OR PERMANENTLY STAMPED ONTO LID.
- 13. QUICK COUPLING VALVES SHALL HAVE PURPLE COVERS AND SHALL BE PER SBWR STANDARD DETAILS.
- 14. NO HOSE BIBS ARE ALLOWED ON THE RECYCLED WATER IRRIGATION SYSTEM. ANY EXTERIOR HOSE BIBS SERVED WITH POTABLE WATER MUST BE LABELED PER SBWR STANDARD DETAILS.
- ALL RECYCLED WATER METERS, DEVICES, AND VALVES E.G. ISOLATION VALVES, IRRIGATION CONTROLLERS, REMOTE CONTROL VALVES, PRESSURE REDUCING VALVES, QUICK COUPLING VALVES, FLOW SENSORS, ETC. SHALL BE TAGGED PER SBWR STANDARD DETAILS.
- LABEL ALL POTABLE WATER METERS AND ABOVE GROUND POTABLE WATER PIPES/ DEVICES (BACKFLOW) PREVENTERS, HOSE BIBS, ETC.) WITH TAGS OR LABELS READING: "POTABLE WATER" IN BLACK LETTERS ON BLUE BACKGROUND, PER SBWR DETAILS.
- 17. ALL RECYCLED WATER IRRIGATION SYSTEMS SHALL HAVE THE FOLLOWING: A. A SWING CHECK VALVE INSTALLED AS CLOSE AS PRACTICABLE TO THE RECYCLED WATER METER BOX (UNLESS OTHERWISE DIRECTED BY SBWR). B. A WYE STRAINER (WITH A 20-MESH OR FINER SCREEN) INSTALLED IMMEDIATELY DOWNSTREAM OF THE
 - SWING CHECK VALVE (IF NO SWING CHECK VALVE REQUIRED, THEN AS CLOSE AS PRACTICABLE TO
 - THE RECYCLED WATER METER BOX). C. A PRESSURE REDUCING VALVE INSTALLED IMMEDIATELY DOWNSTREAM OF THE STRAINER (UNLESS OTHERWISE DIRECTED BY SBWR).
- D. THESE COMPONENTS SHALL BE INSTALLED WITH ISOLATION VALVES TO FACILITATE MAINTENANCE. 18. RECYCLED WATER ADVISORY SIGNS SHALL BE PER SBWR STANDARD DETAILS AND SHALL BE POSTED PER
- LOCATIONS SHOWN ON IRRIGATION PLANS.
- 19. INSTALLATION OF DIRECT INJECTION SYSTEMS ON THE RECYCLED WATER IRRIGATION SYSTEM IS NOT
- 20. NO DRINKING FOUNTAINS OR EATING AREAS ARE ALLOWED IN THE APPROVED RECYCLED WATER USE AREA UNLESS ADEQUATELY PROTECTED FROM OVERSPRAY
- 21. ALL RECYCLED WATER METERS WILL BE SET BY THE LOCAL WATER UTILITY AFTER: A. THE SITE'S OWNER, DEVELOPER, OR CONTRACTOR HAS APPLIED FOR RECYCLED WATER SERVICE WITH THE LOCAL WATER UTILITY, THE WATER SERVICE AGREEMENT HAS BEEN APPROVED, AND ALL APPLICABLE FEES HAVE BEEN PAID. B. THE WATER UTILITY HAS RECEIVED AUTHORIZATION FROM SBWR TO SET RECYCLED WATER METERS.
- 22. NO OVERSPRAY OR RUNOFF OF RECYCLED WATER IS ALLOWED ON ANY NON-APPROVED USE AREA. PONDING OF RECYCLED WATER DUE TO IRRIGATION IS NOT ALLOWED IN ANY AREA. UPON RECEIVING RECYCLED WATER, THE ON-SITE RECYCLED WATER IRRIGATION SYSTEM MUST PASS A COVERAGE TEST PERFORMED BY SBWR INSPECTOR
- 23. CONTRACTOR SHALL SUBMIT AS-BUILT IRRIGATION PLANS TO SBWR.

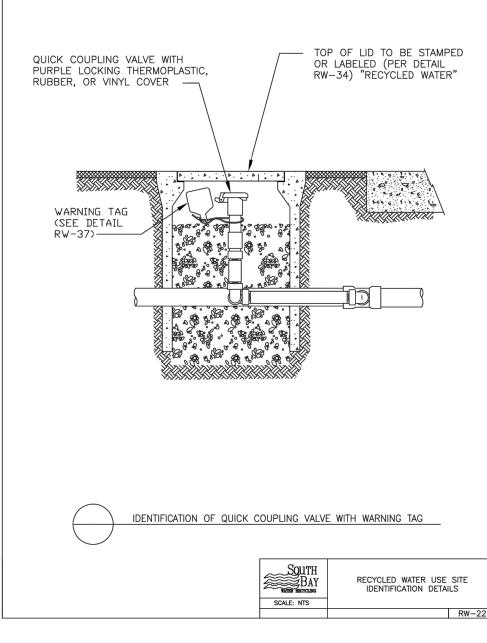

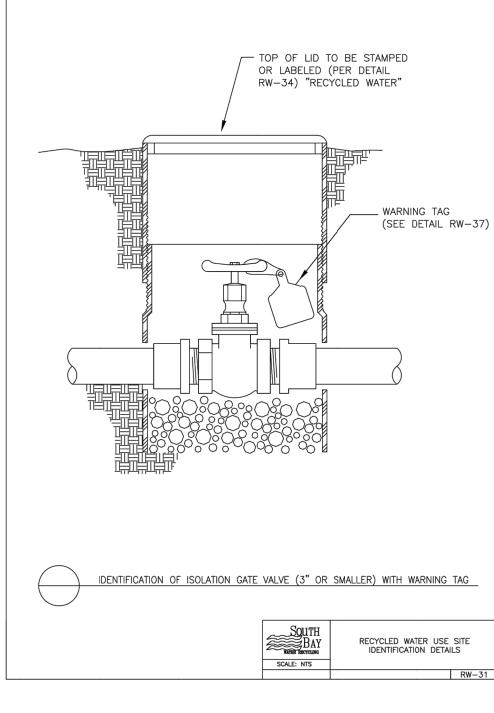


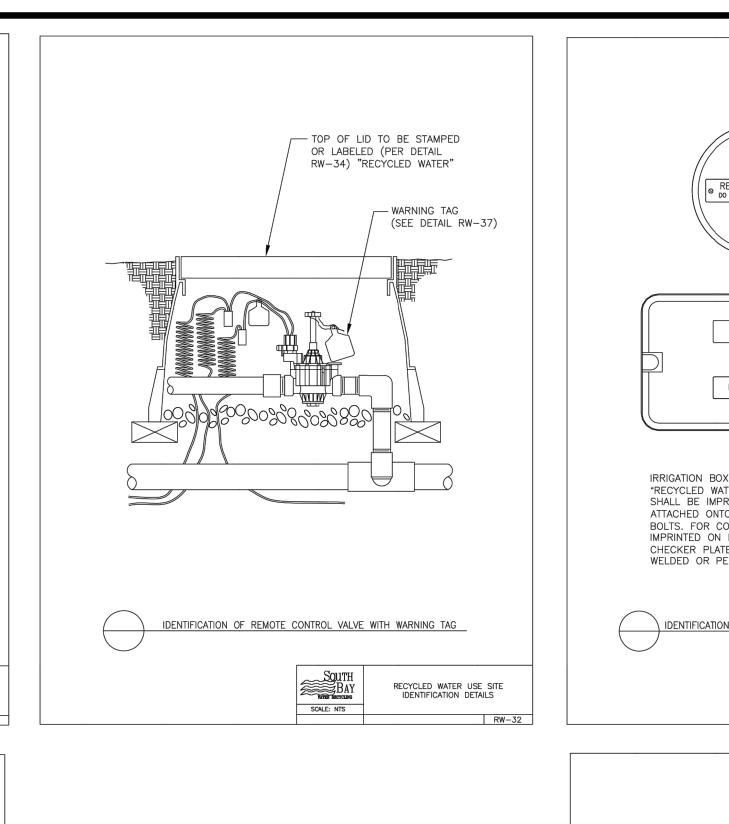


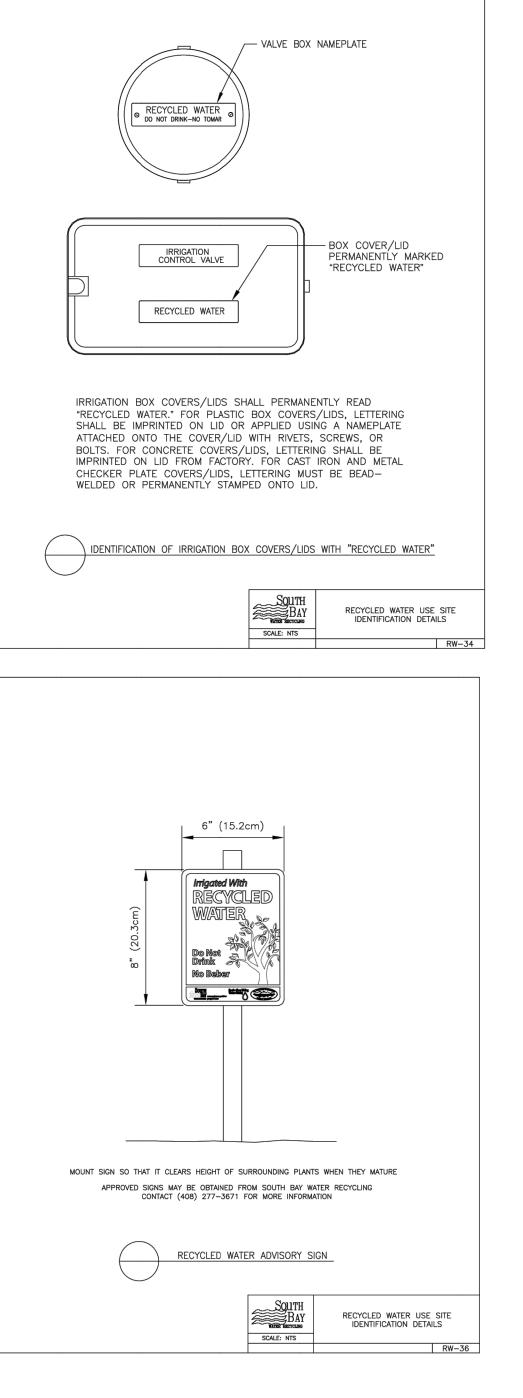

DDW ACCE

WARNING Recycled Water Do Not Drink FRONT BACK SAMPLE WARNING TAG. BACKGROUND PURPLE (PANTONE 512) WITH BLACK LETTERING.	ART & ARCHITECTURE ART & ARCHITECTURE 394-A Umbarger Rd San Jose, CA 95111 Phone 408.224.9890 Fax 408.224.9891 w w . ArtikA3.com Consultant Consultant ART & ARCHITECTURE
IDENTIFICATION OF RECYCLED WATER WARNING TAG	1213 Lincoln Ave, Suite 211 San Jose, CA 95125
SOUTH BAY IDENTIFICATION DETAILS SCALE: NTS	T. 408.292.2196 www.anla-associates.com
RW-37	
HORIZONTAL SEPARATION A minimum horizontal separation of ten feet between parallel, buried re- cycled and potable water pipelines should be maintained. If a ten-foot horizontal separation is not practical, a separation of at least four feet may be allowed subject to special construction conditions. (Designers should consult the Program for specific design re- quirements.) In no case is horizontal	Key Plan
separation of less than four feet or construction in the same trench as Image: Construction requirement Image: Construction requirement	
potable facilities allowed. 10' or greater VERTICAL SEPARATION AT CROSSINGS Where a buried constant pressure recycled water pipeline, it must be located a minimum of 12 inches below the potable water pipeline. Constant pressure recycled water pipelines are allowed over potable water pipelines are allowed over the crossing, or the recycled water pipeline is installed in a pipe sleeve which extends a minimum of 10 feet on either side of the potable water pipeline signification laterals may be located a minimum of 10 feet on either side of the potable water pipeline signification laterals may be located a minimum of 10 feet on either side of the potable water pipeline signification laterals may be located a minimum of 10 feet on either side of the potable water pipeline signification laterals may be located a minimum of the potable without sleeving. NOTE: Intermittently pressurized irrigation laterals may be located a minimum of the potable water pipeline of the potable water pipeline is installed in a pipe sleeve which extends a minimum of 10 feet on either side of the potable water pipeline water pipeline water pipeline is installed in a pipe sleeve which extends a minimum of 10 feet on either side of the potable water pipeline water pipeline water pipeline ble water pipeline of the potable water pipeline water pipeline is without sleeving. Image: State St	
Constant pressure PVC 1.5" diameter and smaller 2.0" diameter and larger Schedule 40 or greater Class 315 or greater	Project Title
Intermittent pressure PVC lateral piping Class 200 or greater Copper piping Type "K" or greater	SCCOE BACKUP
DEPTH OF COVER AND THRUST Type of Recycled Water Piping Minimum Cover	GENERATOR
BLOCKING All on-site recycled water piping must be buried to a minimum depth	1200 Didder Dark Dr. Con. Jose
from finished grade to top of pipe (minimum cover) according to the schedule at right: Intermittent pressure All gives	1290 Ridder Park Dr, San Jose
Constant pressure 2.5" diameter and smaller	SANTA CLARA COUNTY OFFICE
Constant pressure 3" diameter and larger	OF EDUCATION No. Description Date
All recycled water piping other than PVC piping with solvent welded joints must be protected against movement with thrust blocks or restrained joints or other approved methods conforming to the UPC Section 609.1.4.	1BUILDING SUBMITTAL07/11/2022BUILDING RE-SUBMITTAL02/07/2023
Detail RW-RNR1	
	Drawing Title
	SOUTH BAY RECYCLED WATER IRRIGATION NOTES AND DETAILS
	Architect Seal
DW ACCEPTANCE SIGNATURES FOR SBWR PROJECT ID SWC0159AP	
FOR APPROVAL: DATE:	File Number Drawing No
	- Application Number
SBWR - SOUTH BAY WATER RECYCLING DATE:	<u> </u>
DATE:	02.07.2023
	Project No. 06401 ANLA: 2210

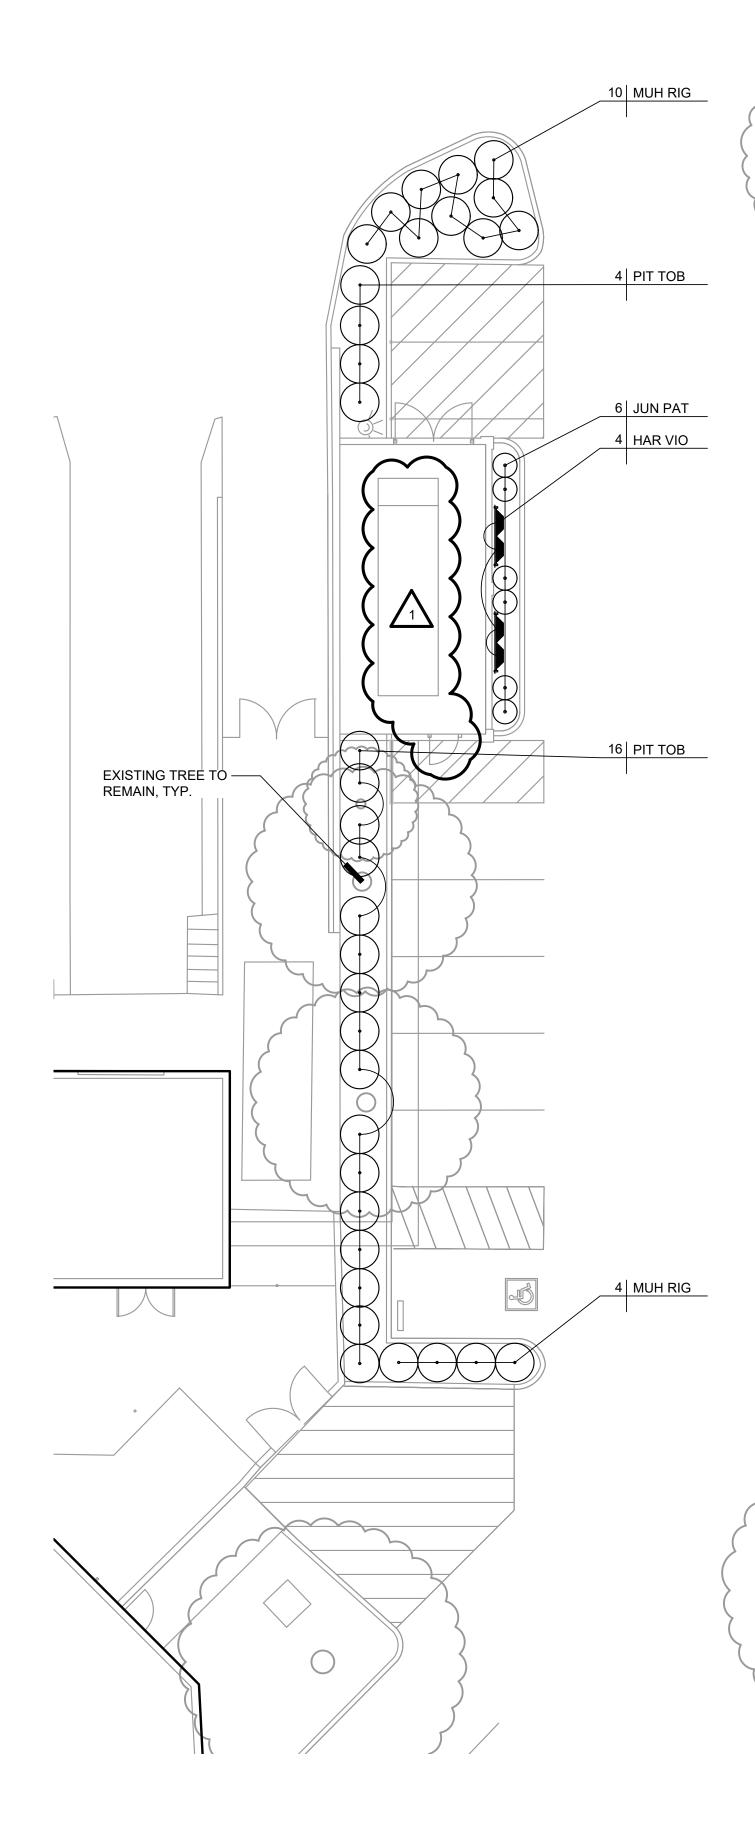

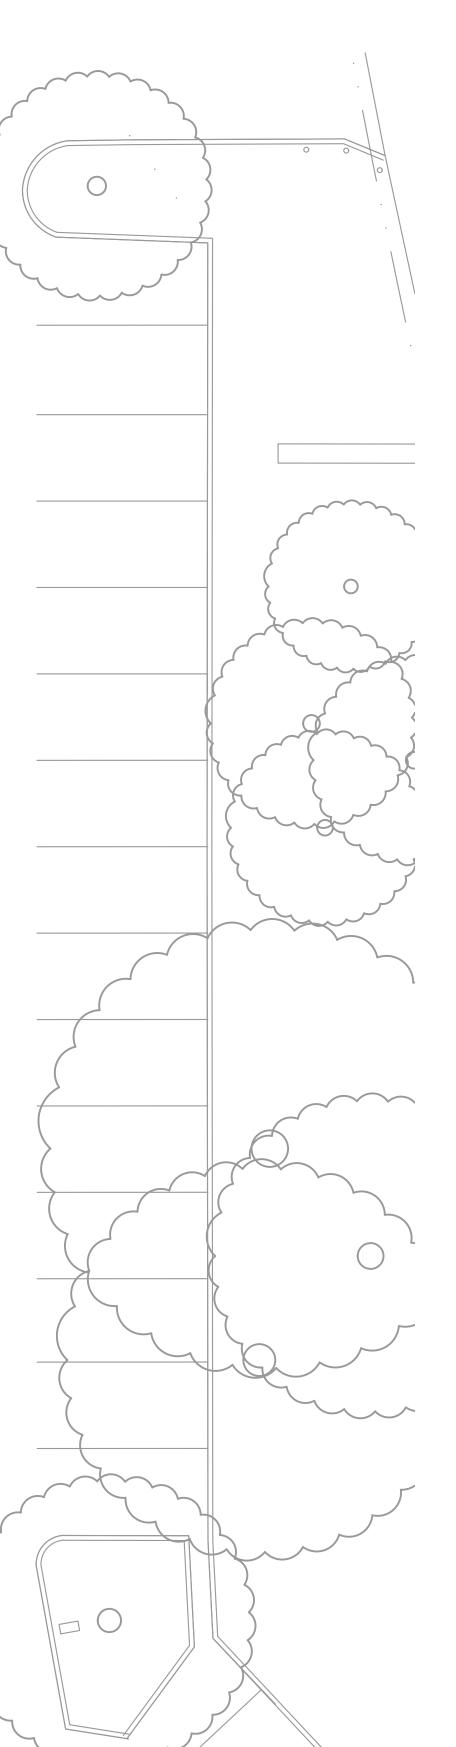

PLANTING NOTES


- 1. THESE NOTES ARE FOR GENERAL REFERENCE IN CON DETAILS, ADDENDA AND CHANGE ORDERS ASSOCIATE
- 2. CONTRACTOR SHALL COORDINATE ALL WORK WITH O
- 3. CONTRACTOR SHALL BECOME FAMILIAR WITH THE LOO IMPROVEMENTS WHICH MAY CONFLICT WITH WORK TO PRIOR TO DIGGING. NOTIFY OWNER IMMEDIATELY SHO
- FINE GRADING, HEADERS AND IRRIGATION COVERAGE OPERATIONS.
- 5. CONTRACTOR SHALL LAY OUT PLANT MATERIAL PER F STRUCTURES OR VIEWS. CONTRACTOR TO OBTAIN AP
- 6. PLANT MATERIAL SHALL NOT BE INSTALLED IN AN ARE IRRIGATION SPRAY PATTERN. NOTIFY THE OWNER'S R
- 7. PLANT LOCATIONS ARE DIAGRAMMATIC AND MAY BE A INSTALLATION. OBTAIN APPROVAL OF PLANT LAYOUT I
- 8. UNLESS OTHERWISE NOTED, FINISH GRADE OF SHRUE DEPTH BARK MULCH TOP DRESSING TO 1/2" BELOW AD TURF AREAS SHALL BE 1/2" BELOW ADJACENT PAVING
- 9. PLANTING AREAS SHALL RECEIVE A 3" MIN. DEPTH BAR AREAS BARK MULCH SHALL BE REPUBLIC SERVICES PL CEDAR BARK MULCH FROM PACIFIC LANDSCAPE SUPP
- 10. NEWLY PLANTED MATERIAL SHALL BE THOROUGHLY S
- 11. EXISTING TREES, SHRUBS AND GROUND COVERS TO R OR NEGLIGENCE SHALL BE REPLACED OR REPAIRED A
- 12. THIRTY DAYS AFTER PLANTING, CONTRACTOR SHALL
- 13. CONTRACTOR TO COLLECT AND SUBMIT SOIL SAMPLE RECOMMENDATION PER SPECIFICATION SECTION 32 9
- 14. CONTRACTOR SHALL COORDINATE ROUGH GRADING A STOCKPILED AND REINSTALLED INTO PROPOSED LAND THERE IS NOT ENOUGH EXISTING TOPSOIL, OR NO PLA PER LANDSCAPE SPECIFICATION SECTION 32 90 00.
- 15. THE CONTRACTOR SHALL BE RESPONSIBLE UNDER TH AND SUBSURFACE SITE FEATURES TO REMAIN, INCLUI PLANT MATERIAL AND/OR TREES DAMAGED OR DESTR THE DAMAGED ITEM(S) WILL BE RESTORED TO THEIR (REPRESENTATIVE.
- 16.REFER TO PLANTING DETAILS THIS SHEET AND SPECIF
329000329000PLANTING
015639015639TEMPORARY TREE AND PLANT

PLANT LEGEND


SYMBOL	SIZE	BOTANICAL NAME
TREES GIN BIL	24" BOX	GINKGO BILOBA 'PRINCETON S
SHRUBS:		
JUN PAT	5 GAL	JUNCUS PATENS
MUH RIG	5 GAL	MUHLENBERGIA RIGENS
PIT TOB	5 GAL	PITTOSPORUM TOBIRA ' VARIE
VINES:		
HAR VIO	5 GAL	HARDENBERGIA VIOLACEA

*WATER NEEDS BASED ON: "WATER USE CLASSIFICATION OF EXTENSION AND THE DEPARTMENT OF WATER RESOURCES

NJUNCTION WITH, AND AS A SUPPLEMENT TO THE WRITTEN SPECIFICATIONS, ED WITH THE CONTRACT DOCUMENTS. OTHER TRADES PRIOR TO INSTALLATION.			ART & ARCHITECTURE
OCATION OF ALL EXISTING AND PROPOSED UNDERGROUND SERVICES AND TO BE DONE. CONTACT UNDERGROUND SERVICE ALERT (USA) AT (800) 642-2444 OULD CONFLICTS ARISE.			 394-A Umbarger Rd San Jose, CA 95111
E SHALL BE APPROVE	D BY THE OWNER'S REPRESENTATI	VE PRIOR TO PLANTING	Phone 408.224.9890 Fax 408.224.9891
	IVE BEST APPEARANCE OR RELATIC ER'S REPRESENTATIVE PRIOR TO IN	,	www.ArtikA3.com
	E HARM TO ADJACENT STRUCTURES OULD CONFLICTS ARISE.	S OR OBSTRUCT	Consultant
	LD AT THE OWNER'S REPRESENTAT REPRESENTATIVE PRIOR TO PLANT		
DJACENT PAVING (1-1	ER AREAS SHALL BE 2" BELOW ADJA /2" DEPTH) WITHIN 2' OF PAVING. FIN ODDED TURF AREAS SHALL BE 1" BI	NISH GRADE OF SEEDED	ANDSCAPE TRANSCAPE TRANSCA
PRO-CHIP MULCH, IN E PLY (209) 593-1199, W	SING, UNLESS OTHERWISE NOTED. BIORETENTION AREAS BARK MULCH WW.PACIFICLANDSCAPESUPPLY.CO	SHALL BE SHREDDED	ASSOCIATES, INC.
	OTECTED. ANY DAMAGE CAUSED B' R'S EXPENSE TO THE SATISFACTION		1213 Lincoln Ave, Suite 211 San Jose, CA 95125
RE-STAKE AND STRA	IGHTEN TREES AS NECESSARY.		T. 408.292.2196 www.anla-associates.com
E TO WAYPOINT ANAL 90 00.	YTICAL FOR SOIL AMENDING AND PI	REPARATION	
IDSCAPE AREAS PER	O ENSURE EXISTING SUITABLE TOP LANDSCAPE SPECIFICATION SECTIO OPSOIL, CONTRACTOR SHALL IMPO	ON 32 90 00. IN THE EVENT	
IDING BUT NOT LIMITE ROYED, BOTH ON THIS	REPAIRING OR REPLACING, AT HIS O ED TO STRUCTURES, FENCES, WALI S PROPERTY OR THOSE PROPERTIE I OR REPLACED TO THE SATISFACTI	LS, PAVING SURFACES, S ADJACENT TO THIS SITE.	Key Plan
FICATIONS SECTIONS	S:		
			_
	COMMON NAME	WATER NEEDS*	
SENTRY'	PRINCETON SENTRY GINKGO	MODERATE	
	CALIFORNIA GREY RUSH	LOW	
EGATA'	DEER GRASS VARIEGATED MOCK ORANGE	LOW MOD	
			Project Title
	PURPLE VINE LILAC	MOD	SCCOE BACKUP GENERATOR
0F LANDSCAPE SPECII 5, 2014.	ES", ZONE 1, UNIVERSITY OF CALIFC	ORNIA COOPERATIVE	1290 Ridder Park Dr, San Jose
			SANTA CLARA COUNTY OFFICE OF EDUCATION
			No.DescriptionDate1BUILDING SUBMITTAL07/11/2022
			BUILDING RE-SUBMITTAL07/11/2022BUILDING RE-SUBMITTAL02/07/2023
			Drawing Title
			PLANTING PLAN
			Architect Seal
	•	NORTH	File Number - Application Number - I O 1
		SCALE: 1" = 10'-0"	Date 02.07.2023
	0'	5' 10' 20'	ANLA: 2210

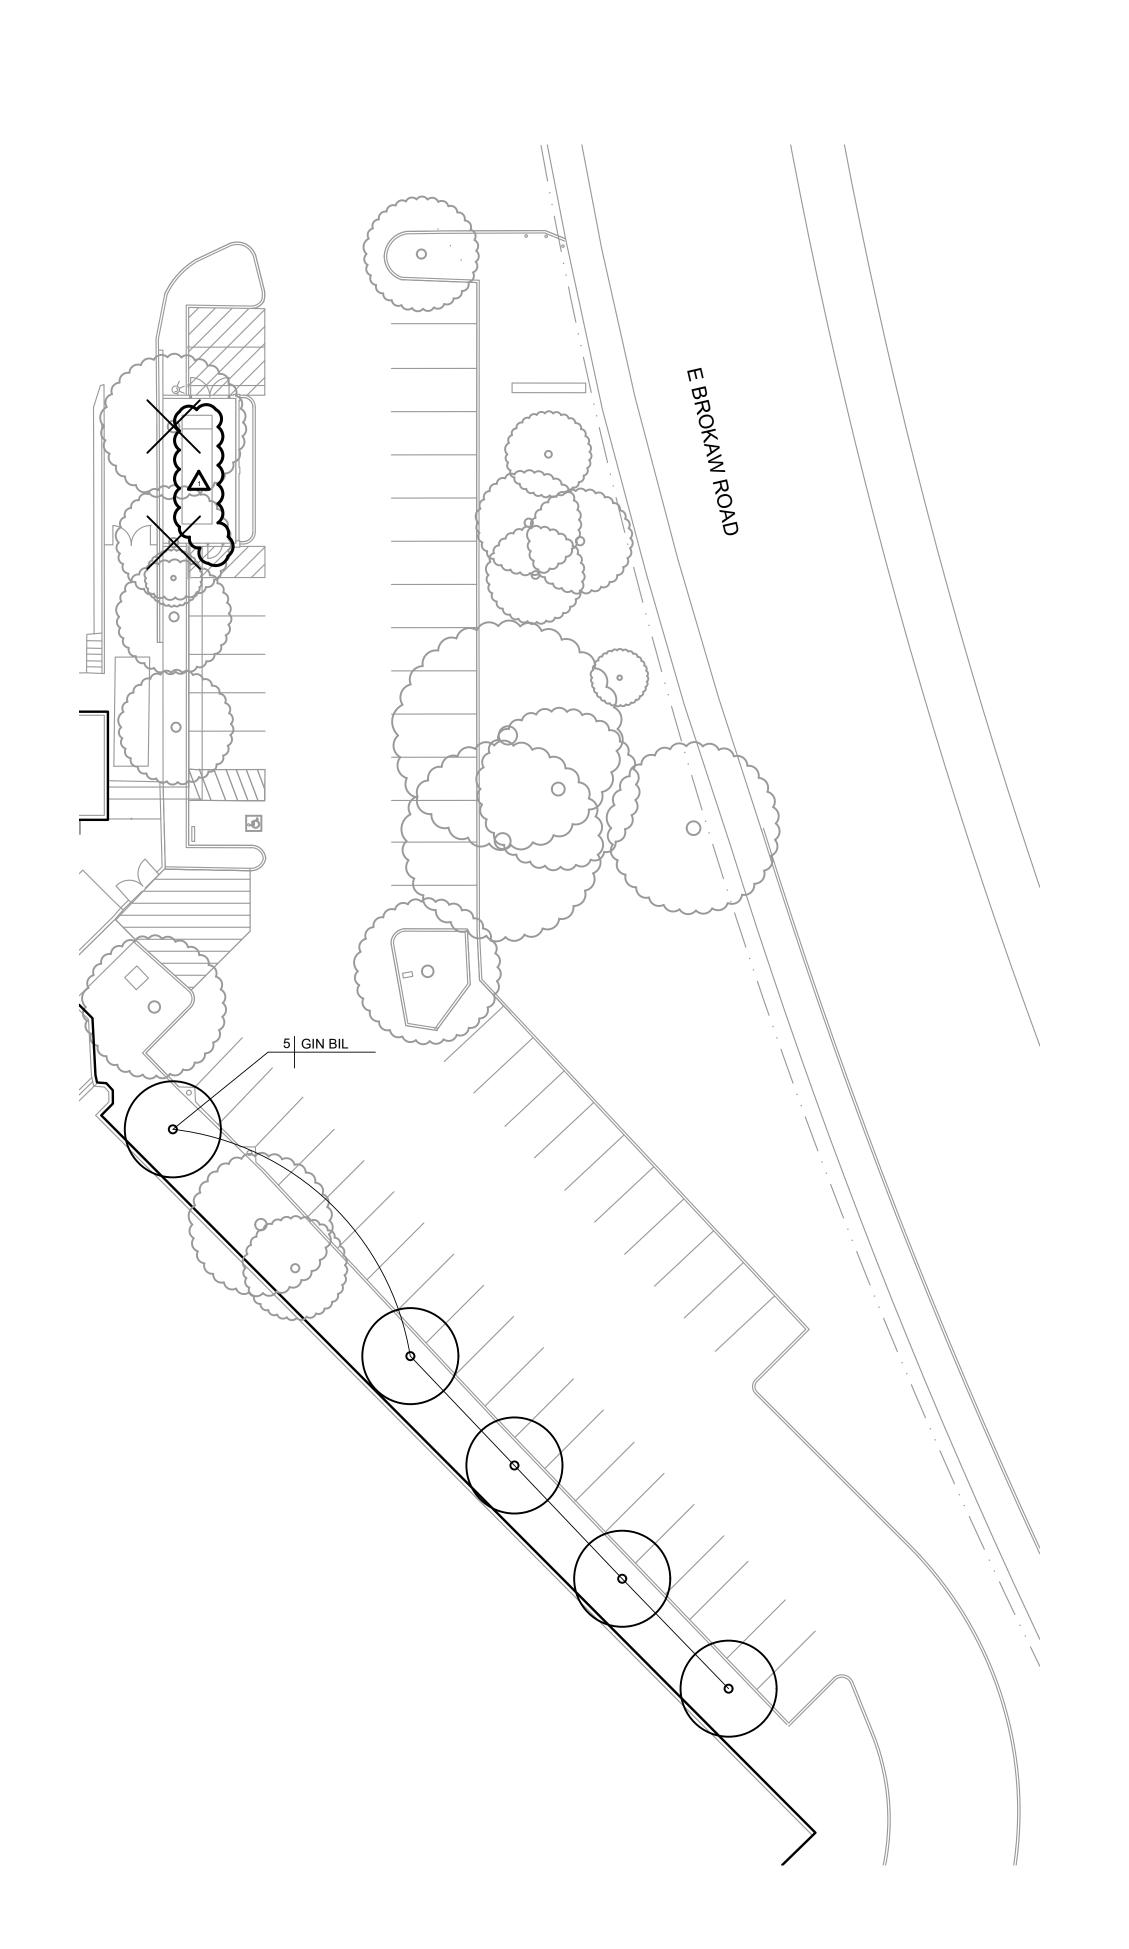

TREE MITIGATION LEGEND

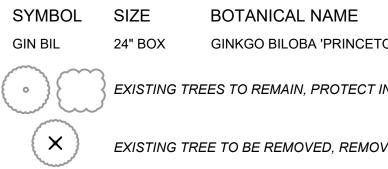

*WATER NEEDS BASED ON: "WATER USE CLASSIFICATION EXTENSION AND THE DEPARTMENT OF WATER RESOURC

TREE MITIGATION NOTES


- 1. PROPOSED REMOVAL OF (2) NON-ORDINANCE TRE
- 2. CIRCUMFERENCE OF EACH TREE TO BE REMOVED
 3. MITIGATION TREE QUANTITIES:
- (4) 15 GALLON TREES OR (2) 24" BOX TREES REQUI (5) 24" BOX TREES PROPOSED.
- 4. NEW TREE PLANTING TO RECEIVE IRRIGATION FRO SPRAY HEADS AS NECESSARY TO ACHIEVE 100% C
- 5. REFER TO TREE PRESERVATION DETAIL A, L2.3


TREE REMOVAL NOTES

- 1. THE LIMITS AND SCOPE OF DEMOLITION SHOWN HE REMOVAL WORK. PRECISE LIMITS OF PAVEMENT RE DRAINAGE PLAN. THE CONTRACTOR SHOULD ALSO ARCHITECTURAL PLANS AND THE CONSTRUCTION I THE OWNER'S REPRESENTATIVE
- 2. DEMOLITION WORK SHALL CONFORM TO CAL GREE AND 5.408.4 (EXCAVATED SOIL AND LAND CLEARING THE MOST STRINGENT CODE SHALL PREVAIL.
- 3. REFER TO PLANTING NOTES AND LEGEND, SHEET I


COMMON NAME WATER* ON SENTRY' PRINCETON SENTRY GINKGO MODERATE N PLACE VE STUMP AND ROOTS, TYP. ON OF LANDSCAPE SPECIES", ZONE 1, UNIVERSITY OF CALIFORNIA COOPERATIVE ICES, 2014.	ART & ARCHITECTURE 394-A Umbarger Rd San Jose, CA 95111 Phone 408.224.9890 Fax 408.224.9891 w w. ArtikA3.com
EES. D IS LESS THAN 38". IRED. OM EXISTING IRRIGATION SYSTEM IN ITS RESPECTIVE PLANTER. ADJUST OR ADD COVERAGE.	$\begin{tabular}{ c c c c c c c c c c c c c c c c c c c$
IEREON ARE TO PROVIDE THE CONTRACTOR WITH A GENERAL SCOPE OF TREE REMOVAL AND GRADING SHOULD BE TAKEN FROM THE CIVIL GRADING AND O REFERENCE THE ARCHITECTURAL PLANS AND OTHER LANDSCAPE N DOCUMENTS FOR A COMPLETE SCOPE OF WORK. VERIFY ALL DEMOLITION WITH REN CODE SECTION 5.408.3 (CONSTRUCTION WASTE REDUCTION BY AT LEAST 50%) IG DEBRIS), AND LOCAL CONSTRUCTION WASTE MANAGEMENT REQUIREMENTS. L2.1	Key Plan
	Project Title SCCOE BACKUP GENERATOR
	1290 Ridder Park Dr, San Jose SANTA CLARA COUNTY OFFICE OF EDUCATION No. Description Date 1 BUILDING SUBMITTAL 07/11/2022 BUILDING RE-SUBMITTAL 02/07/2023 Image: Drawing Title Image: Drawing Title
	Architect Seal
SCALE: 1" = 20'-0"	File NumberDrawing NoApplication NumberImage: Constraint of the second secon

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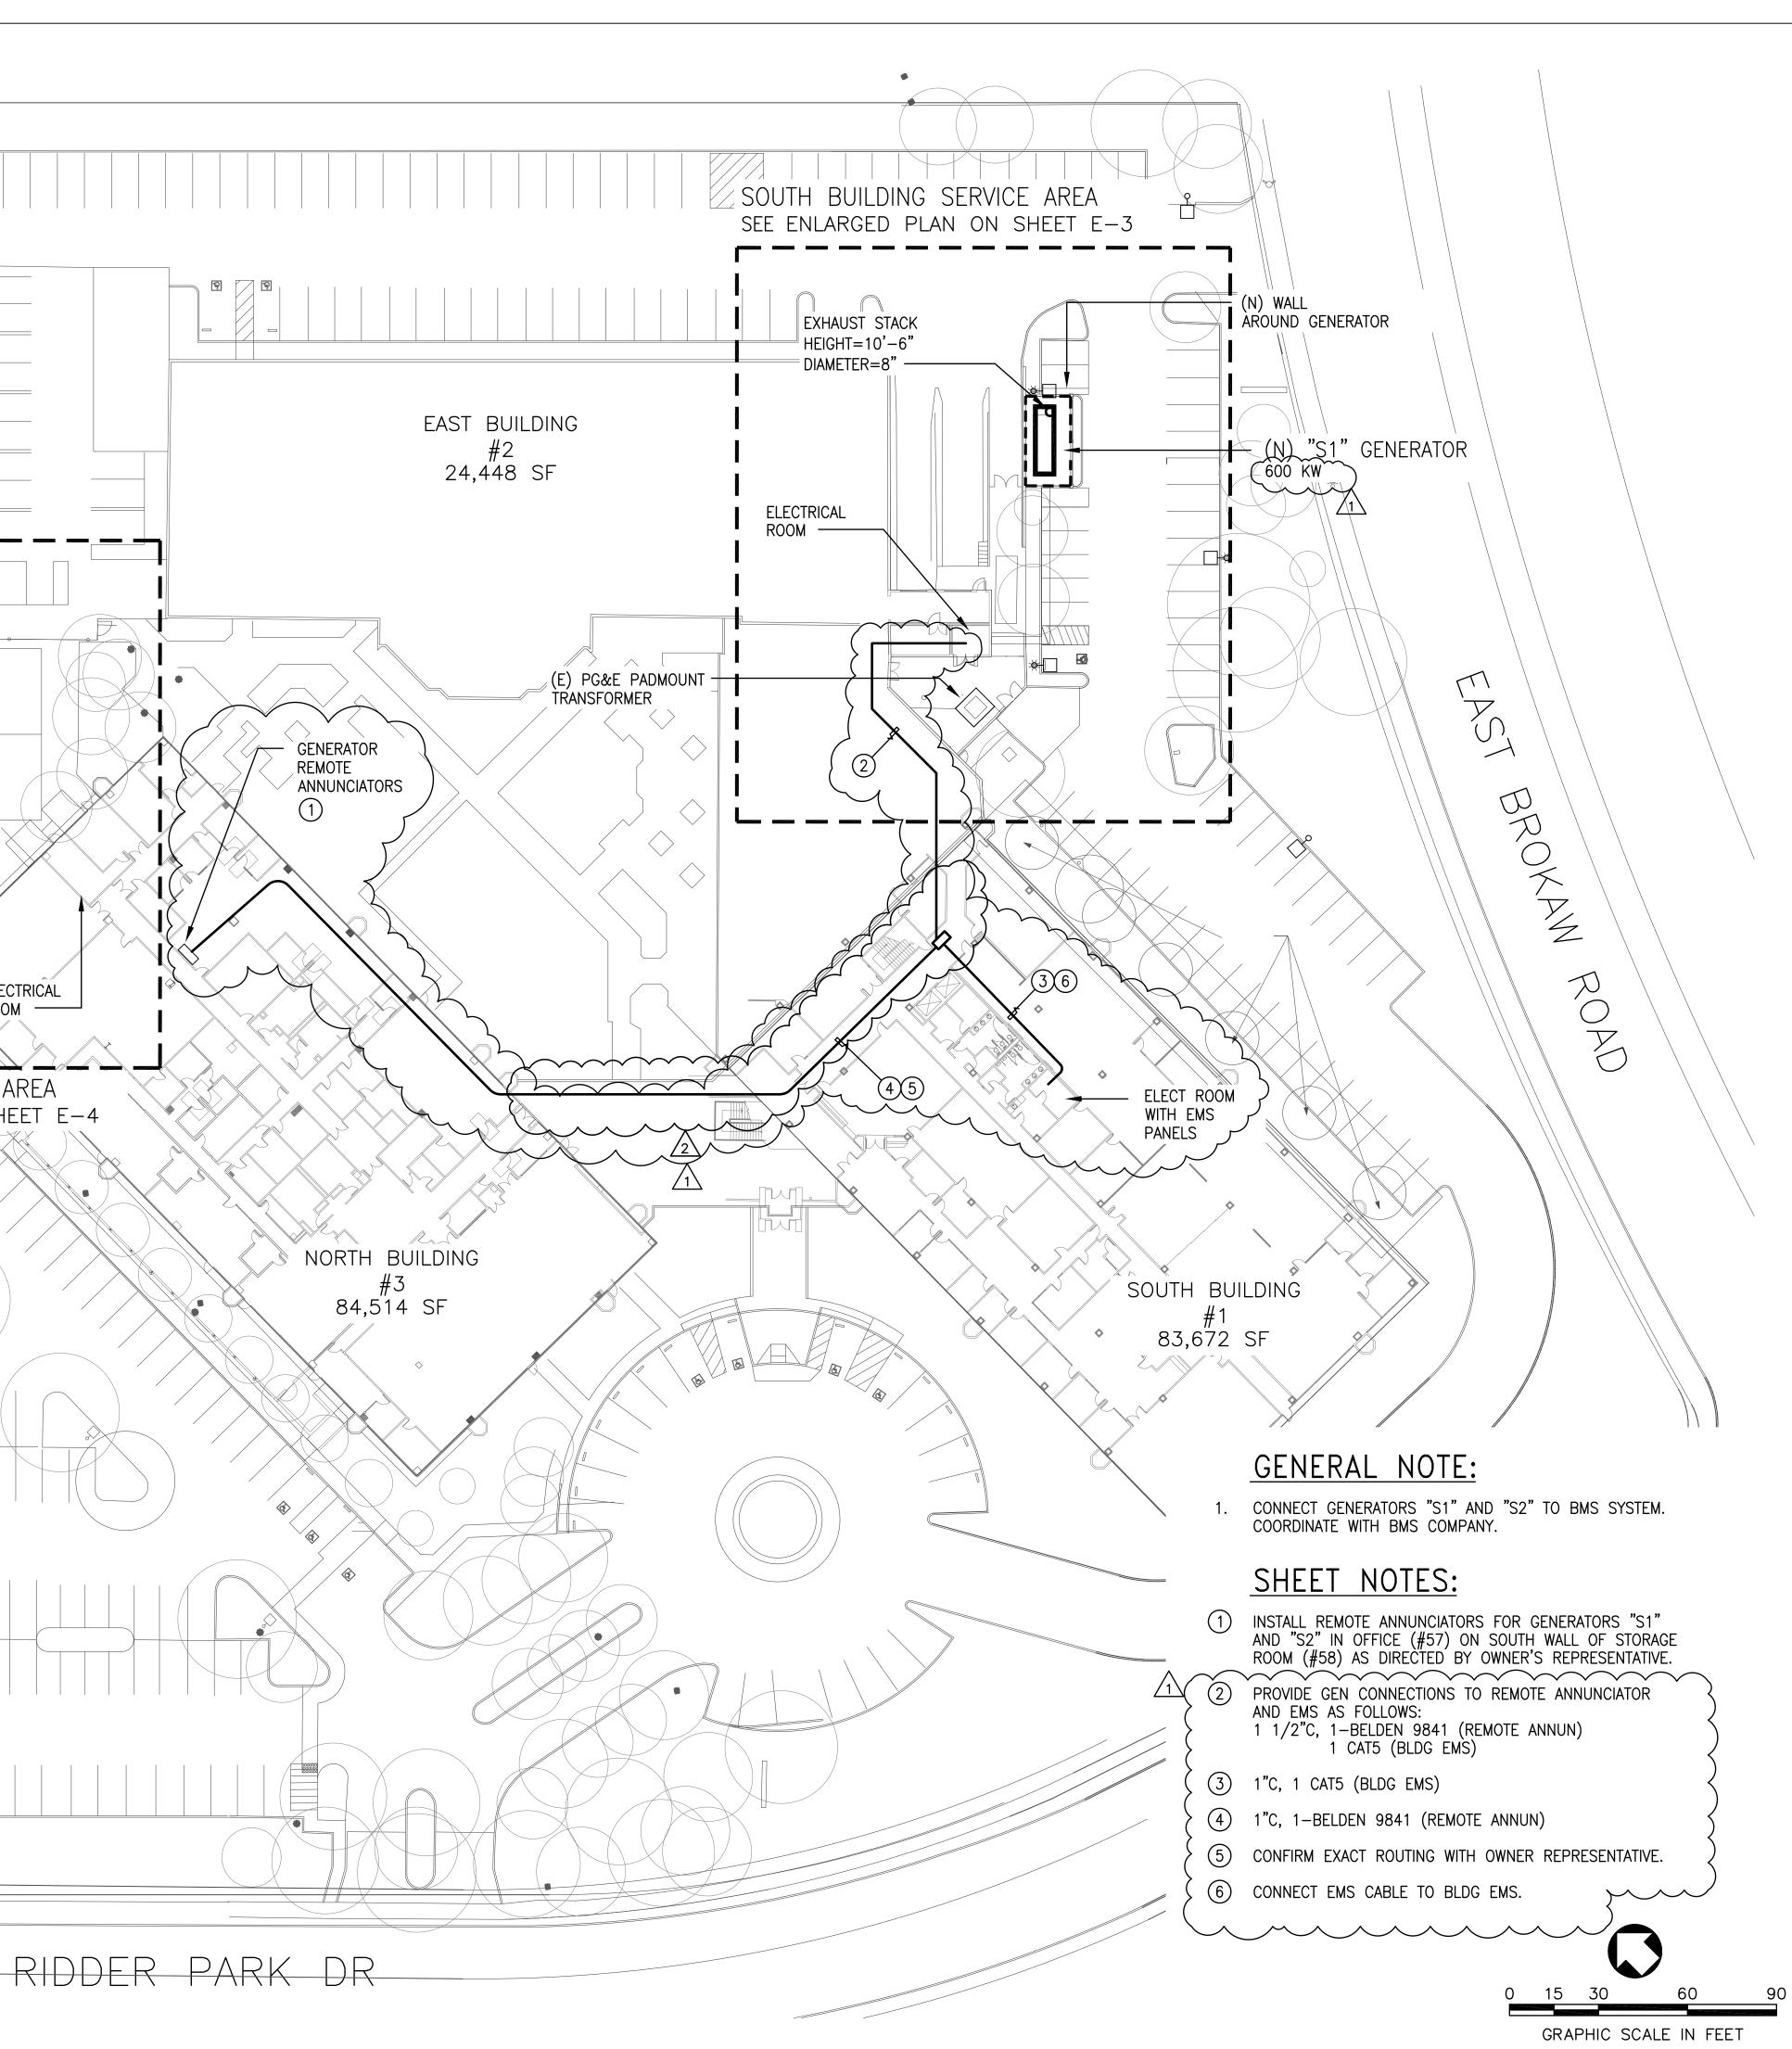


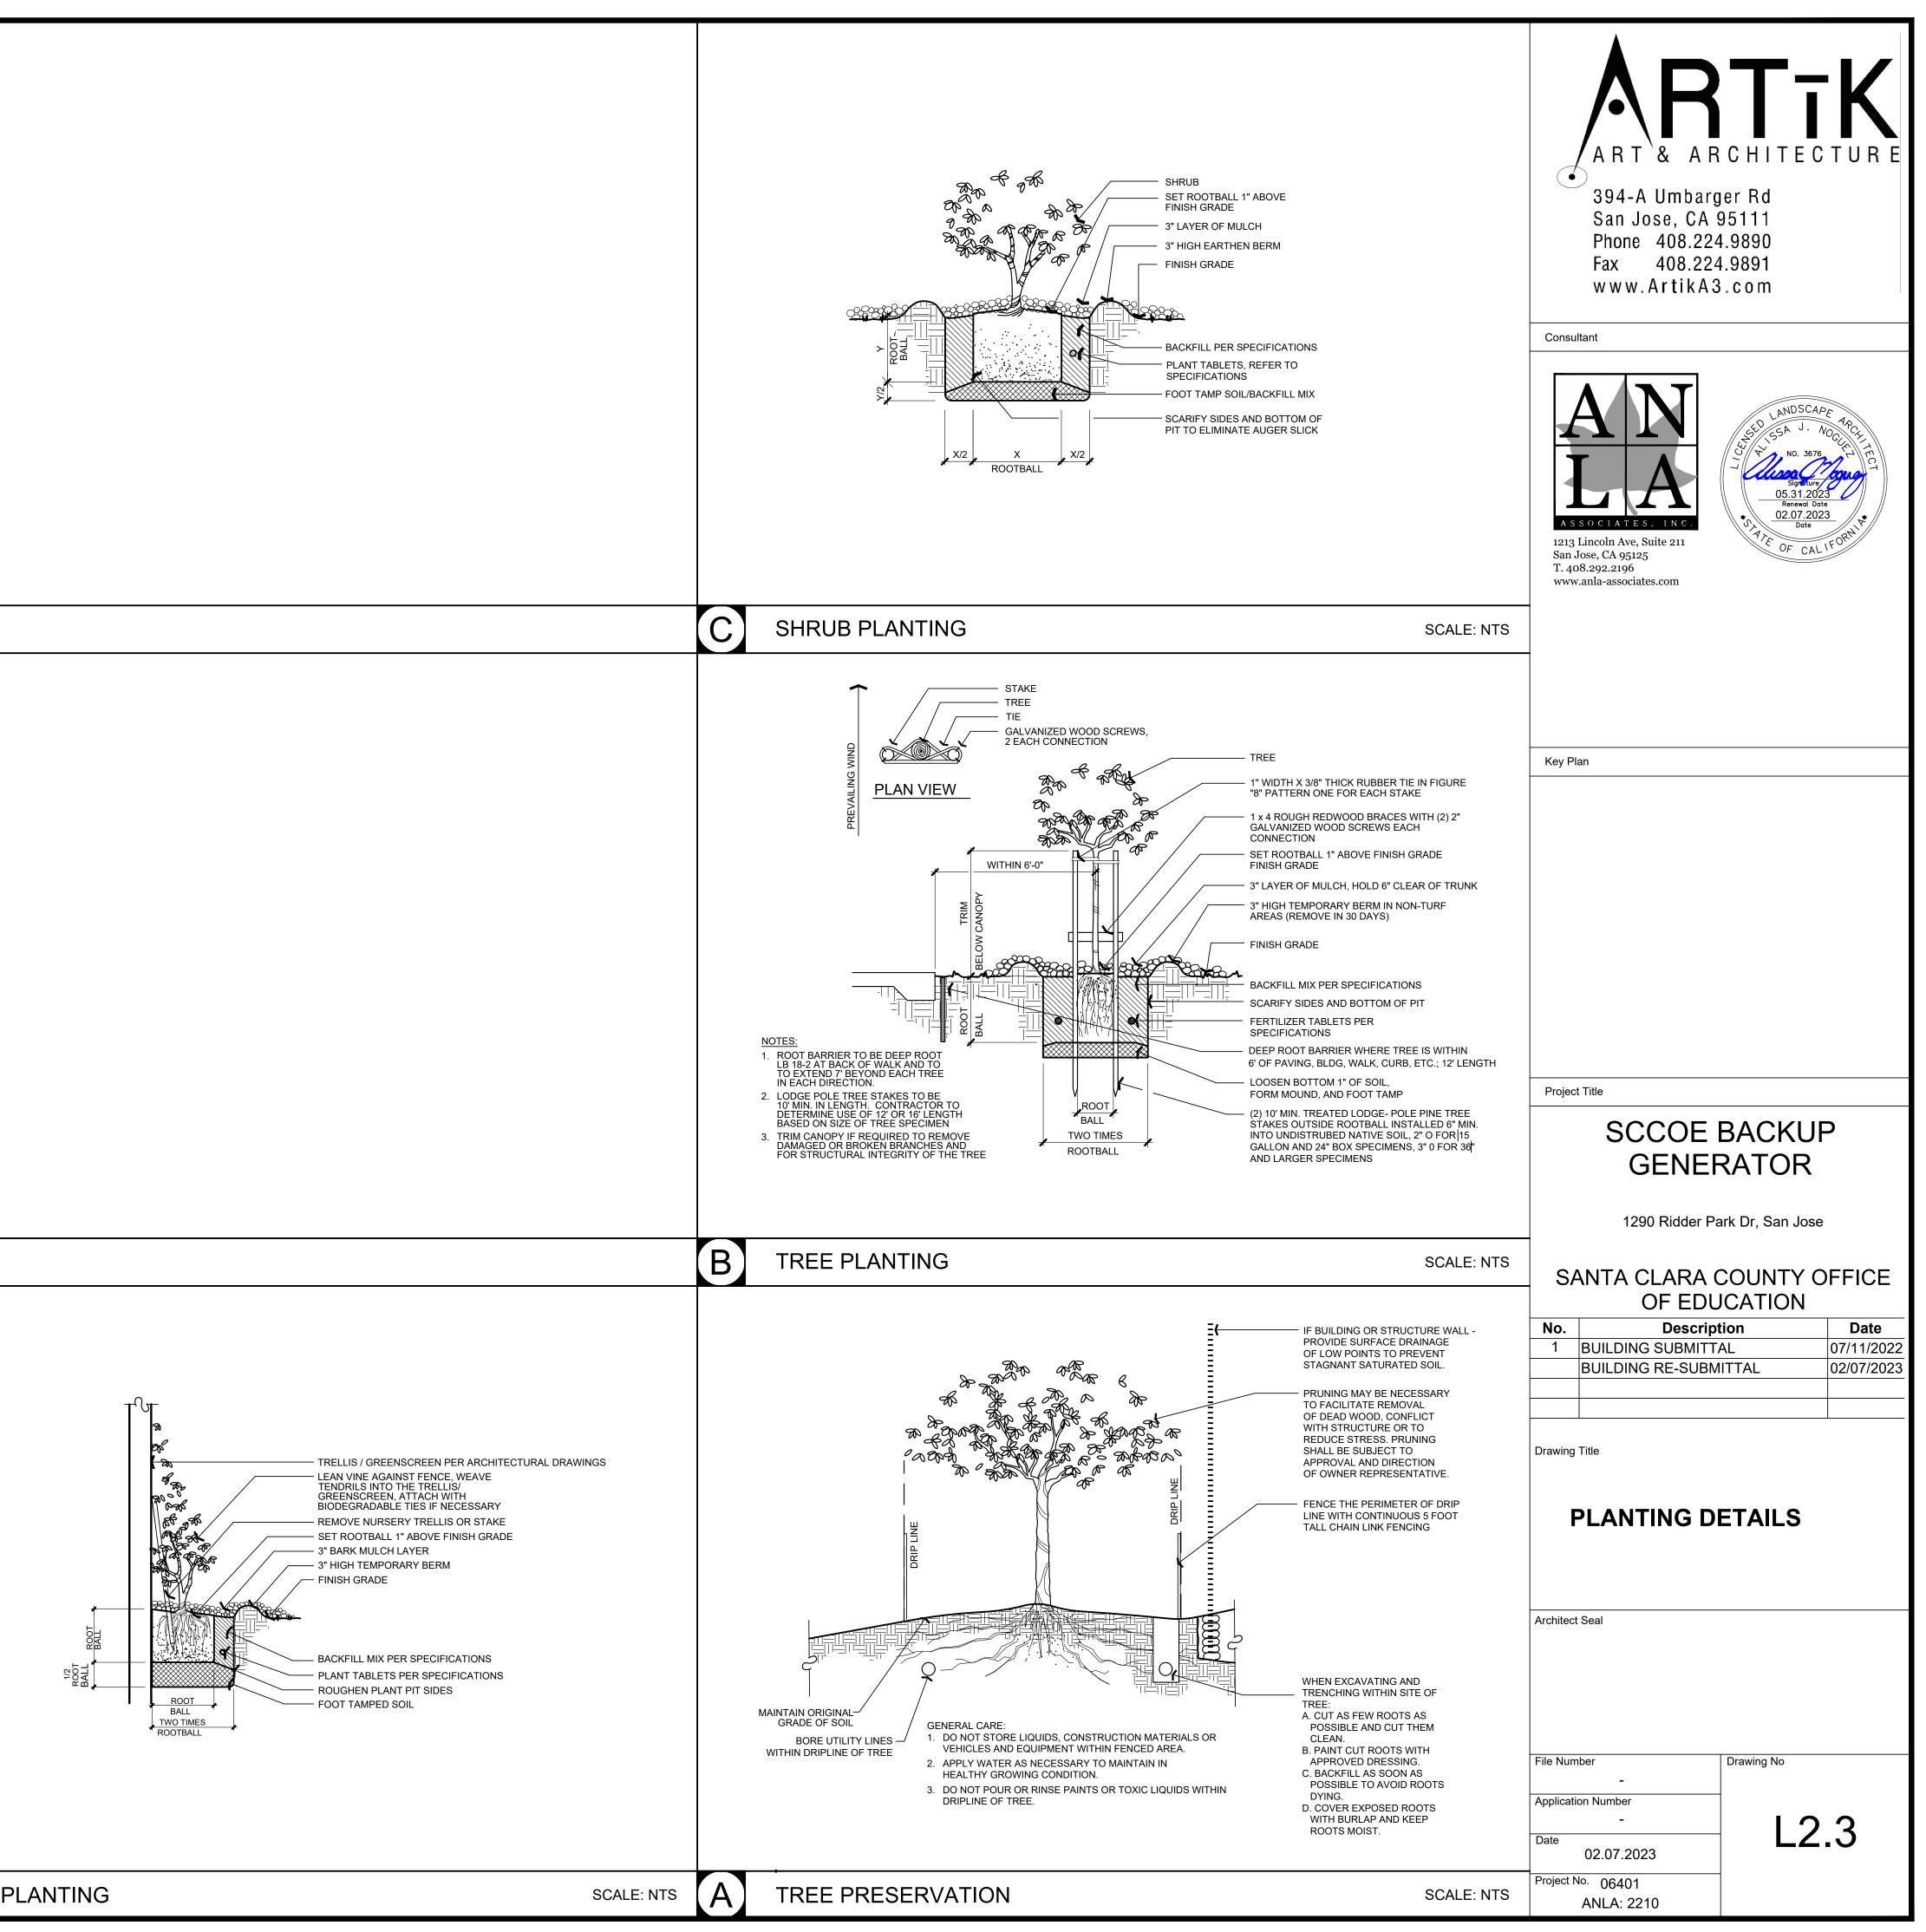


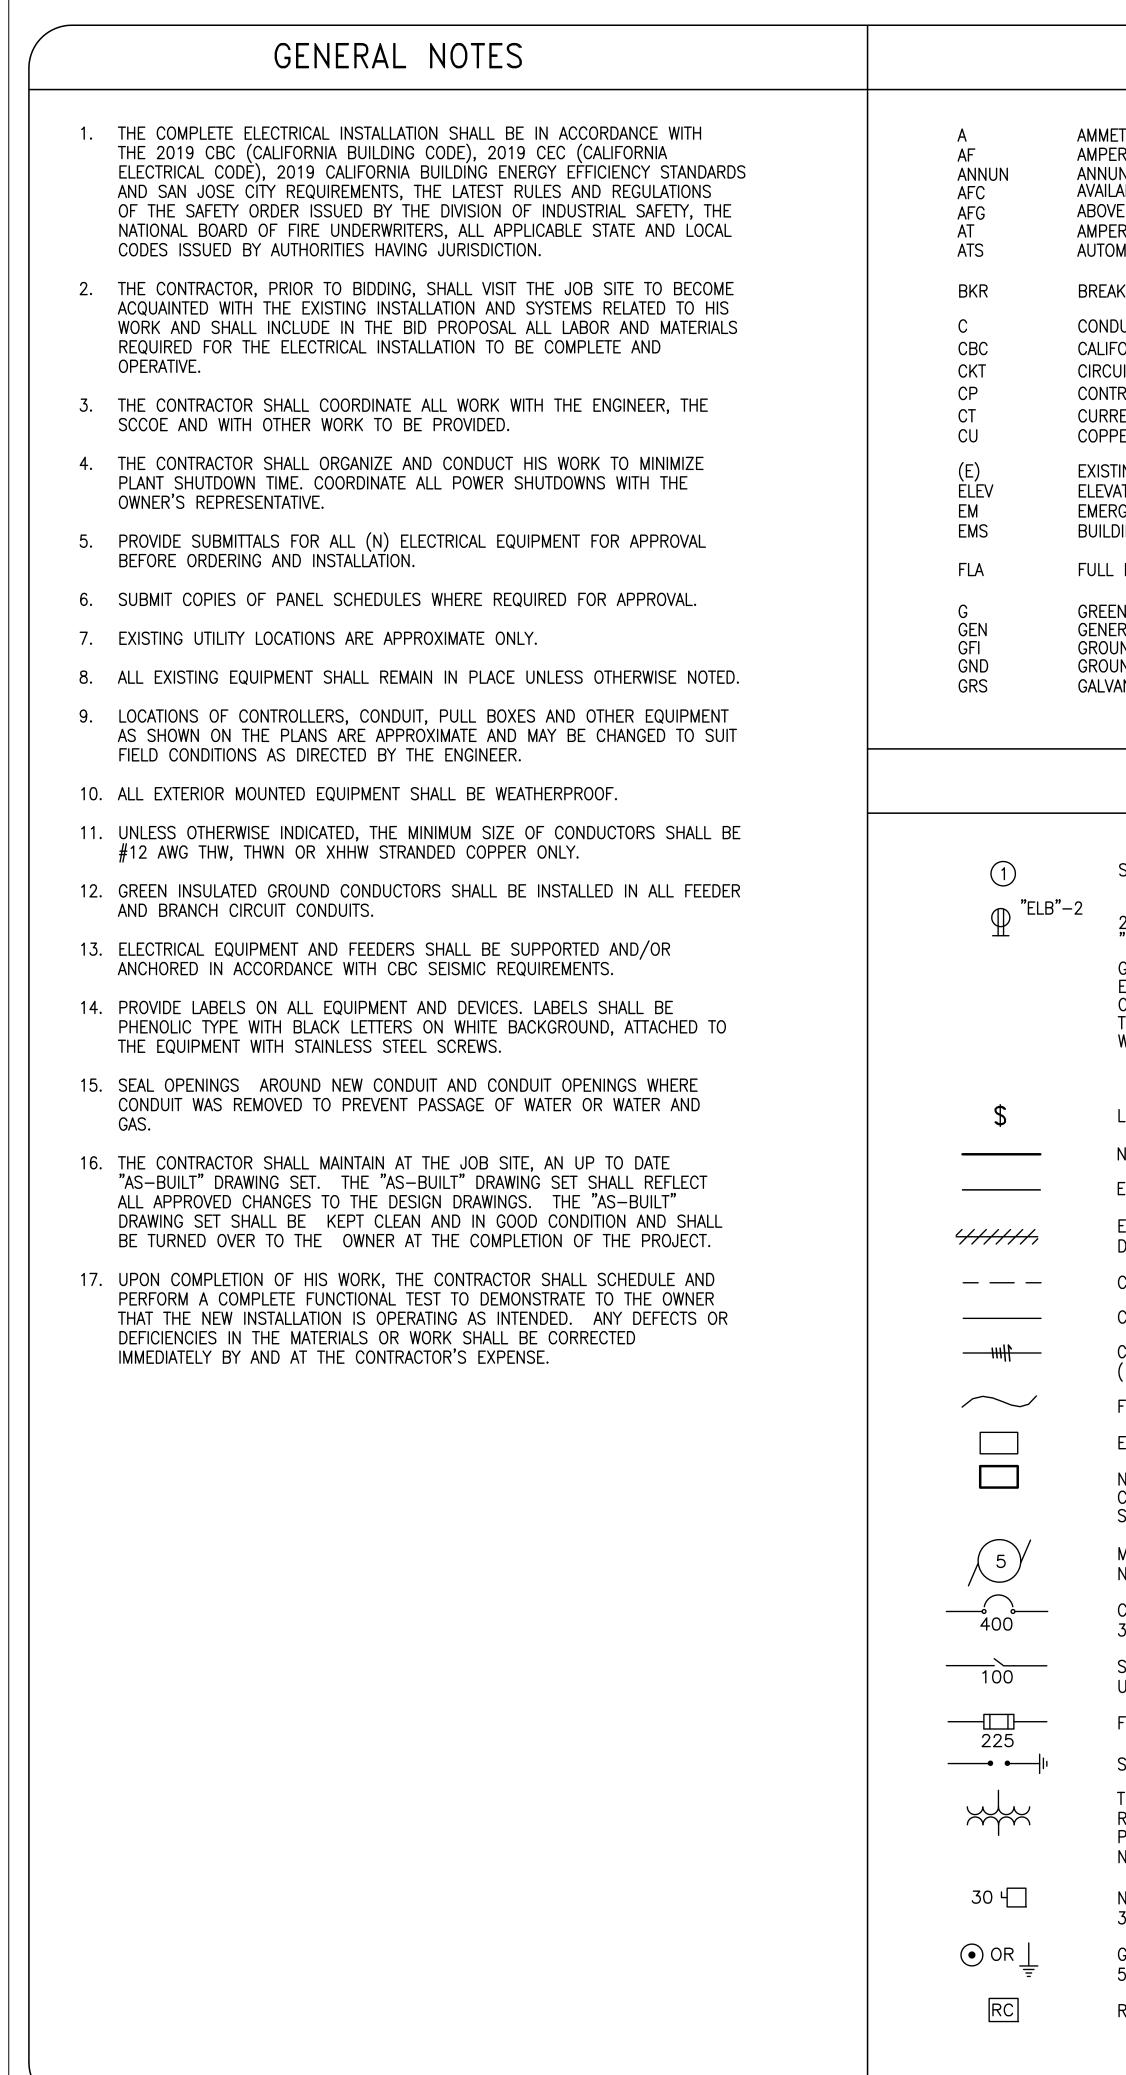
ABBRE	/IATIONS		
ETER, AMPERE, AMBER ERE FRAME UNCIATOR LABLE FAULT CURRENT VE FINAL GRADE ERE TRIP OMATIC TRANSFER SWITCH AKER DUIT, CONTACTOR, CONTROL FORNIA BUILDING CODE CUIT TROL PANEL RENT TRANSFORMER PER STING /ATOR RGENCY DING ENERGY MANAGEMENT SYSTEM L LOAD AMPS EN, GROUND, GENERATOR ERATOR UND FAULT INTERRUPTER/5mA UND /ANIZED RIGID STEEL CONDUIT	INST KAIC KVA KW LT FLEX LTG MSB MT MTS (N) PCGRS PNL PQM RCPT SCCR SPD ST TP TSP UON	INSTANTANEOUS THOUSAND AMPERE INTERRUPTING CAPACITY KILOVOLT AMPERE KILOWATT LIQUID TIGHT FLEX CONDUIT LIGHTING MAIN SWITCHBOARD EMPTY MANUAL TRANSFER SWITCH NEW PVC COATED GALVANIZED RIGID STEEL CONDUIT PANEL POWER QUALITY METER RECEPTACLE SHORT CIRCUIT RATING SURGE PROTECTION DEVICE SHUNT TRIP TWISTED PAIR TWISTED PAIR TWISTED SHIELDED PAIR UNLESS OTHERWISE NOTED	E-1 ELECTRICAL GENER E-2 EMERGENCY POWE E-3 ENLARGED PLAN E-4 ENLARGED PLAN E-5 SINGLE LINE DIAG E-6 SINGLE LINE DIAG E-7 GENERATOR DETAI E-8 SWITCHBOARD DET E-9 SWITCHBOARD DET E-10 PG&E SHORT CIR
LEGI SHEET NOTE REFERENCE 20A, 125V DUPLEX RECEPTACLE, NEMA "ELB"-2 INDICATES PANEL "ELB" CKT 2 GFI – GROUND FAULT PROTEC EX – EXPLOSION PROOF CRE – CORROSION RESISTANT TL – TWIST LOCK WP – WEATHERPROOF LIGHT SWITCH +45" U.O.N. NEW ELECTRICAL EQUIPMENT EXISTING ELECTRICAL EQUIPMENT ELECTRICAL EQUIPMENT TO BE DISCONNECTED AND REMOVED CONDUIT RUN UNDERGROUND OR BELOW CONDUIT RUN ABOVE GRADE OR ON CE	5–20R, +18", 2, RED COLOR IF TED W FLOOR		NORTH BUILDIN THE SCOPE OF WORK INCLUD PROVIDES BACKUP TO ONLY TO THAT WILL PROVIDE BACKUP TO SOUTH BUILDIN THE SCOPE OF WORK INCLUD PROVIDE BACKUP POWER FOR PLANTS OF DIRT AREA
CONDUIT RUN WITH WIRES. () INDICATES (1) INDICATES HOT WIRES FLEXIBLE METAL CONDUIT EXISTING PRE CAST CONCRETE PULL BO NEW PRE CAST CONCRETE PULLBOX COVER MARKED "ELECTRICAL" SEE CALTRANS STANDARD PLAN ES-E8. MOTOR, SQUIRREL CAGE INDUCTION NUMBER IF PRESENT INDICATES HORSEF CIRCUIT BREAKER, THERMAL MAGNETIC T 3 POLE UNLESS INDICATED OTHERWISE. SWITCH – CURRENT RATING INDICATED, UNLESS INDICATED OTHERWISE. FUSE – RATING INDICATED SURGE ARRESTER TRANSFORMER, SECONDARY VOLTAGES, IN RATING INDICATED AS APPLICABLE PUSH-BUTTON SWITCH, MOMENTARY CO NORMALLY OPEN NON FUSED DISCONNECT SWITCH, SIZE 3 POLE UNLESS INDICATED OTHERWISE. GROUND ELECTRODE, 5/8"\$ X 10'-0" COPPER CLAD STEEL REMOVE AND BECOME PROPERTY OF CO	DX POWER TRIP SHOWN, 3 POLE PHASE AND NTACT, INDICATED,		ELECTRICAL AND CONTROL CONDUIT

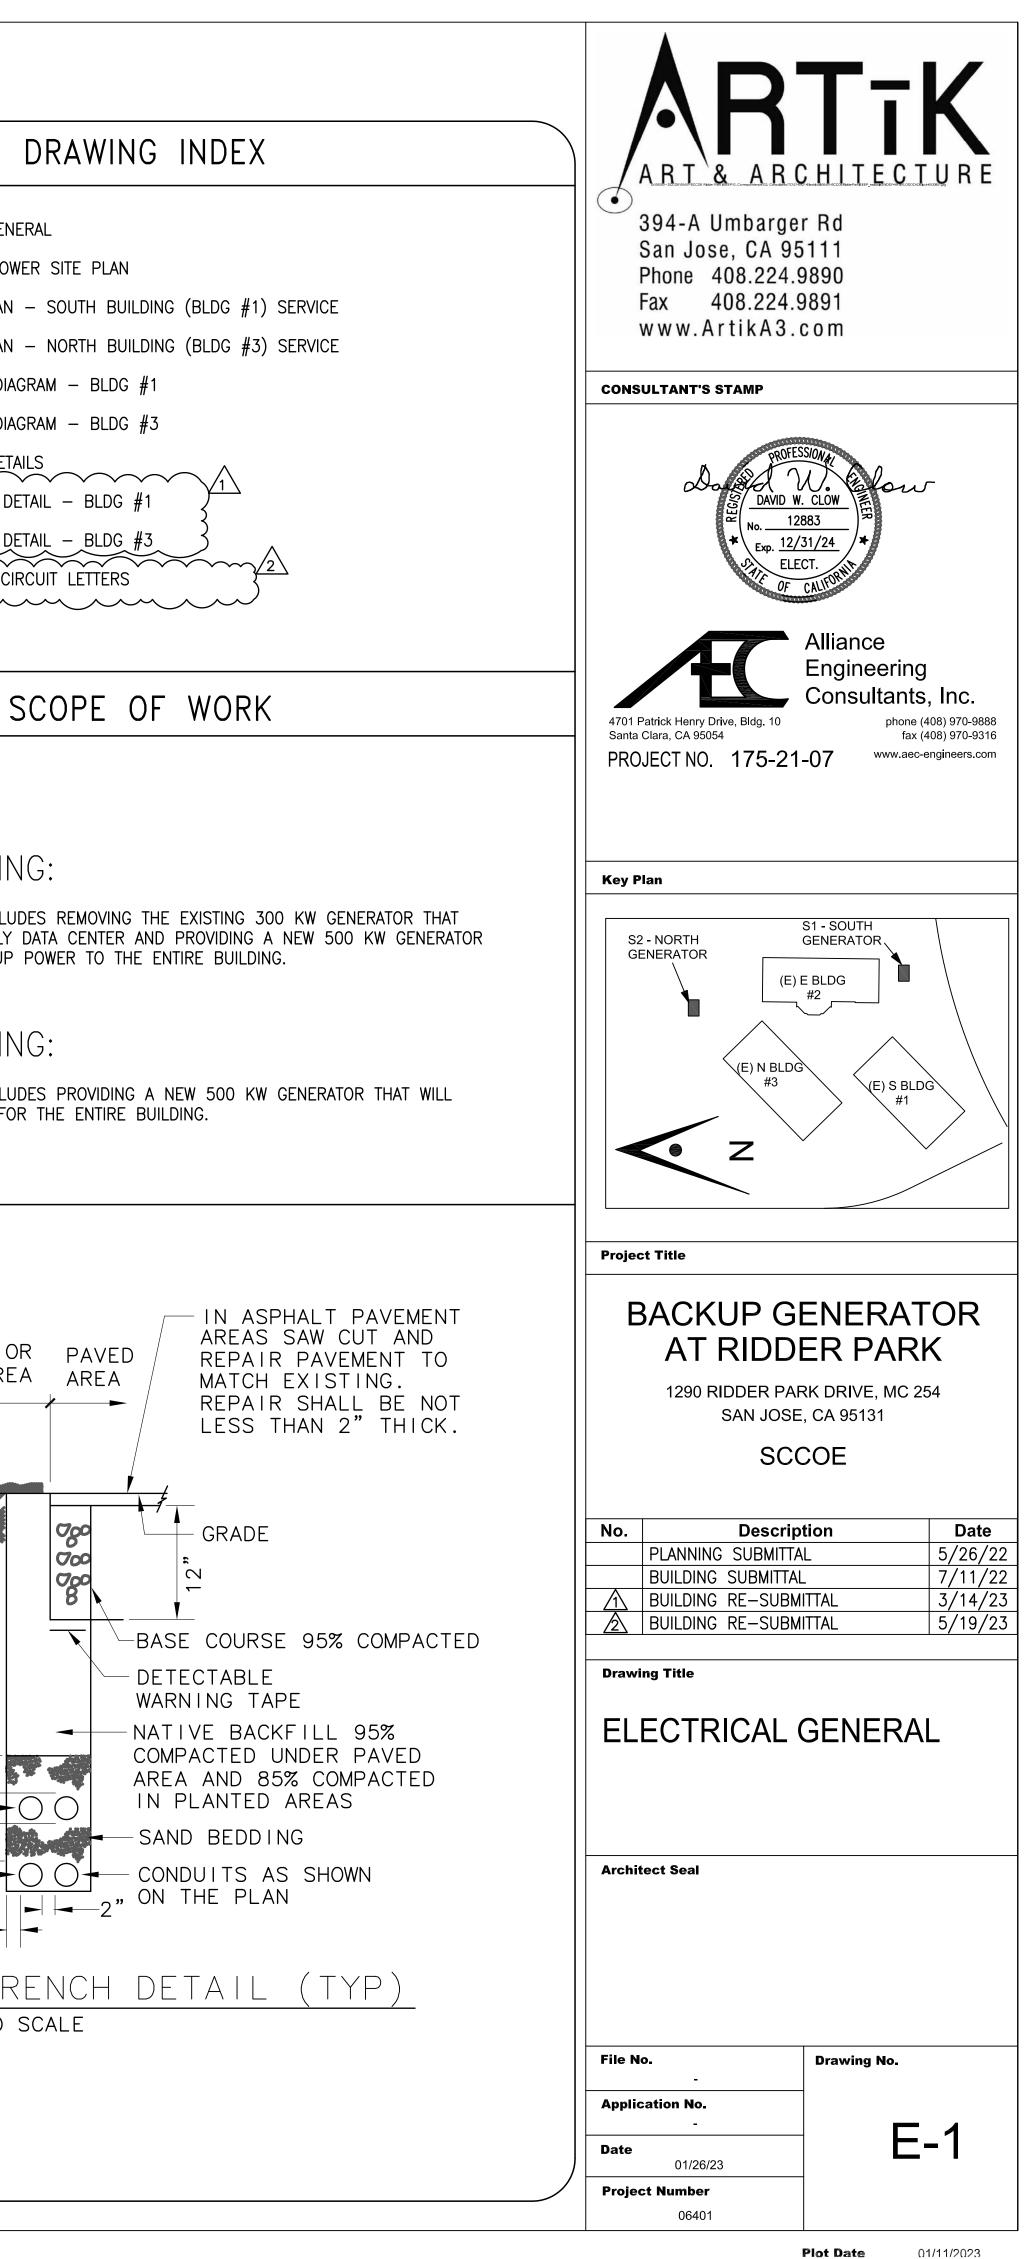

EXHAUST STACK HEIGHT=10'-6" DIAMETER=8"
(N) "S2" GENERATOR (E) GENERATOR TO BE REMOVED (N) MTS (E) PG&E PADMOUNT
TRANSFORMER TRANSFORMER ELECTRICAL ROOM I NORTH BUILDING SERVICE AREA SEE ENLARGED PLAN ON SHEET E-4



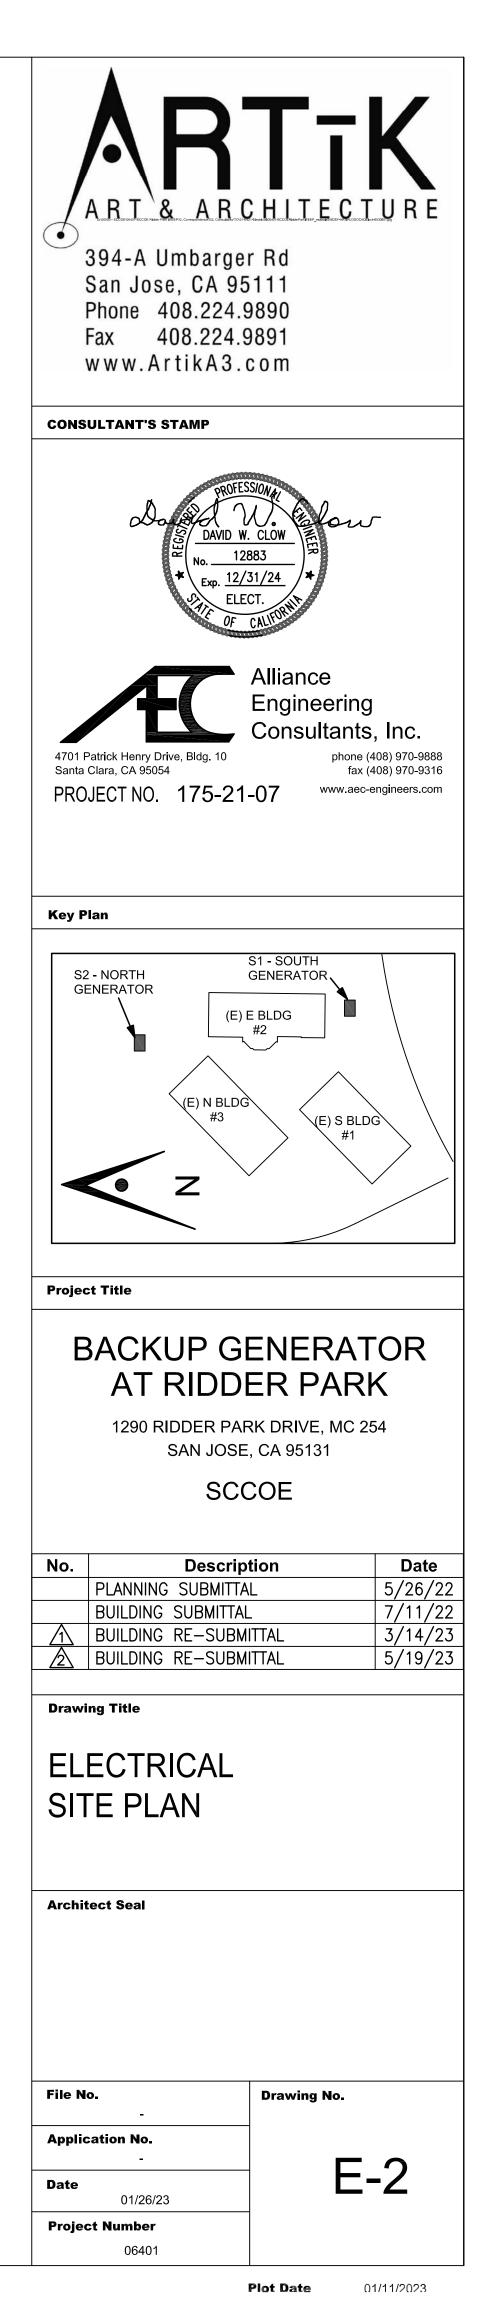

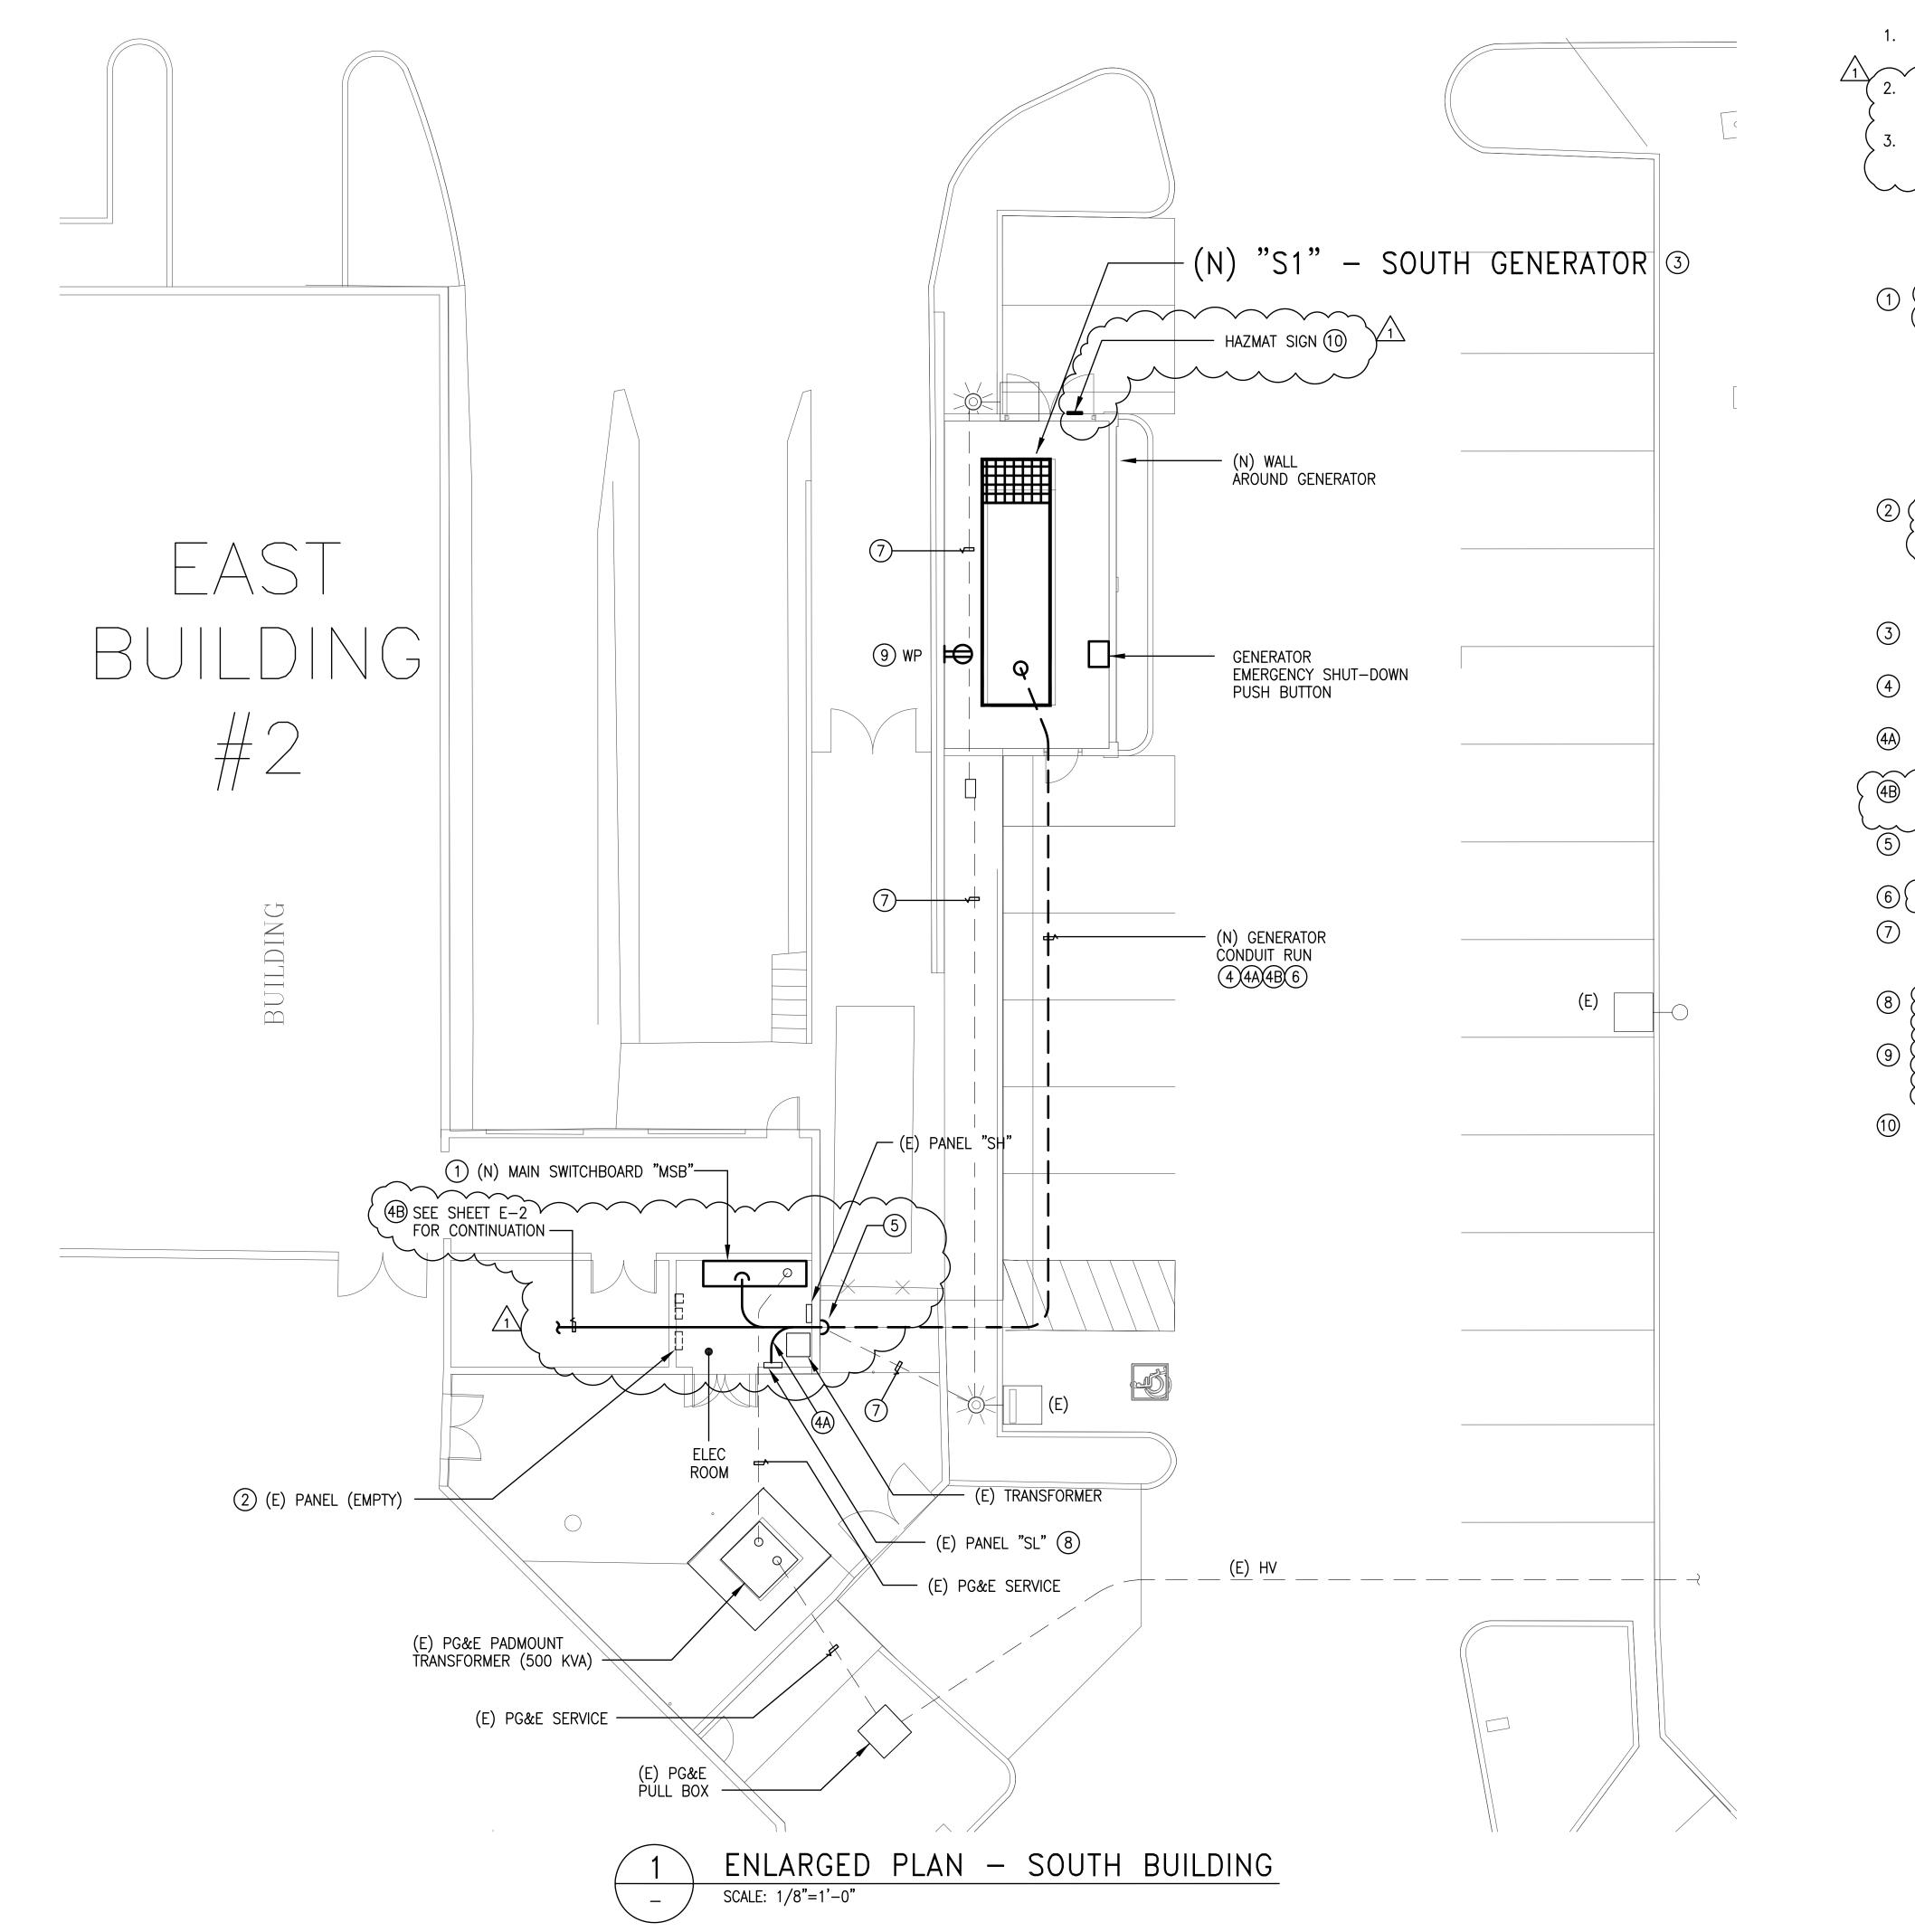


GENERAL NOTES: 1. ALL (E) ELECTRICAL EQUIPMENT SHALL REMAIN IN PLACE, UON. 2. SEAL ALL CONDUIT OPENING AS SHOWN IN DETAILS ON ART & ARCHITECTURE SHEET E-8. •) 394-A Umbarger Rd THE CONTRACTOR SHALL LOCATE EXISTING UTILITIES BEFORE San Jose, CA 95111 EXCAVATION. Phone 408.224.9890 \sim \sim Fax 408.224.9891 www.ArtikA3.com SHEET NOTES: CONSULTANT'S STAMP (a. COORDINATE A POWER SHUTDOWN WITH PG&E AND OWNER REPRESENTATIVE. ······ b. DISCONNECT THE (E) PG&E SERVICE CABLES AND ALL OTHER FEEDER CABLES FROM (E) MSB. DAVID W. CLOW c. RC (E) IEM SWBD AND INSTALL A NEW SWBD IN THE. 12883 SAME LOCATION. SEE SHEET E-5 AND E-8 FOR WORK ∖ Exp. <u>12/31/24</u> REQUIRED. ELECT d. RECONNECT ALL THE (E) CABLES TO (N) MSB. (REMOVE (E) UN-USED EMPTY PANEL AND ADJUST Alliance a. SMALL PANEL LOCATIONS AS NEEDED TO MAKE SPACE FOR Engineering GENERATOR PROGRAMMED TRANSFER CONTROLS. Consultants, Inc. b. COORDINATE WITH PG&E TO RE-CONNECT THE ELECTRIC 4701 Patrick Henry Drive, Bldg. 10 phone (408) 970-9888 SERVICE. Santa Clara, CA 95054 fax (408) 970-9316 PROJECT NO. 175-21-07 www.aec-engineers.com \bigcirc INSTALL (N) 600 KW GENERATOR. SEE SHEET E-7 FOR DETAILS. (4) 3-4 "C WITH CONDUCTORS PER NOTE (4) ON SHEET E-5. 1-1/2"C, 2#10 (GEN START) Key Plan 1-1/2"C, 3#4 (GEN PANEL) 1#8 (Ġ) S1 - SOUTH S2 - NORTH GENERATOR (4B) 1-1/2"C, 1 - BELDEN 9841 (REMOTE ANNUN) GENERATOR 1 – CAT5 (BLDG EMS) (E) E BLDG CONDUIT RISES ON OUTSIDE WALL, PENETRATES WALL #2 AND RUNS IN CEILING SPACE. INSTALL CONDUITS IN 24" WIDE TENCH. (E) N BLDG #3 ····· (E) S BLDG MAINTAIN (E) PARKING LIGHT CONDUIT AND CONDUCTORS IN OPERATION DURING CONSTRUCTION. REPLACE IF DAMAGED DURING CONSTRUCTION. Ζ $\underline{\qquad}$ 8 {RC UNUSED CB'S AND INSTALL NEW 70A/2P FOR GEN ACCESSORIES PANEL. (9) { INSTALL WEATHERPROOF 125 V, 20A, NEMA 5–20R RECEPTACLE AND CONNECT TO 20A CKT BKR IN GEN PANEL WITH 3/4"C, Project Title 2#12 AND 1#12 (G). **BACKUP GENERATOR** (10) PROVIDE 16"x16" ALUMINUM HAZMAT SIGN. SEE ARCH /1\ PLANS. AT RIDDER PARK 1290 RIDDER PARK DRIVE, MC 254 (RED) SAN JOSE, CA 95131 SCCOE (BLUE) 0 (YELLOW) No. Date Description 5/26/22 PLANNING SUBMITTAL 7/11/22 3/14/23 BUILDING SUBMITTAL BUILDING RE-SUBMITTAL (WHITE) 5/19/23 BUILDING RE-SUBMITTAL **Drawing Title** ENLARGED PLAN -SOUTH BLDG #1 SERVICE **Architect Seal** File No. Drawing No. **Application No. E-3** Date 01/26/23 GRAPHIC SCALE IN FEET **Project Number**


Plot Date 01

06401

01/11/2023

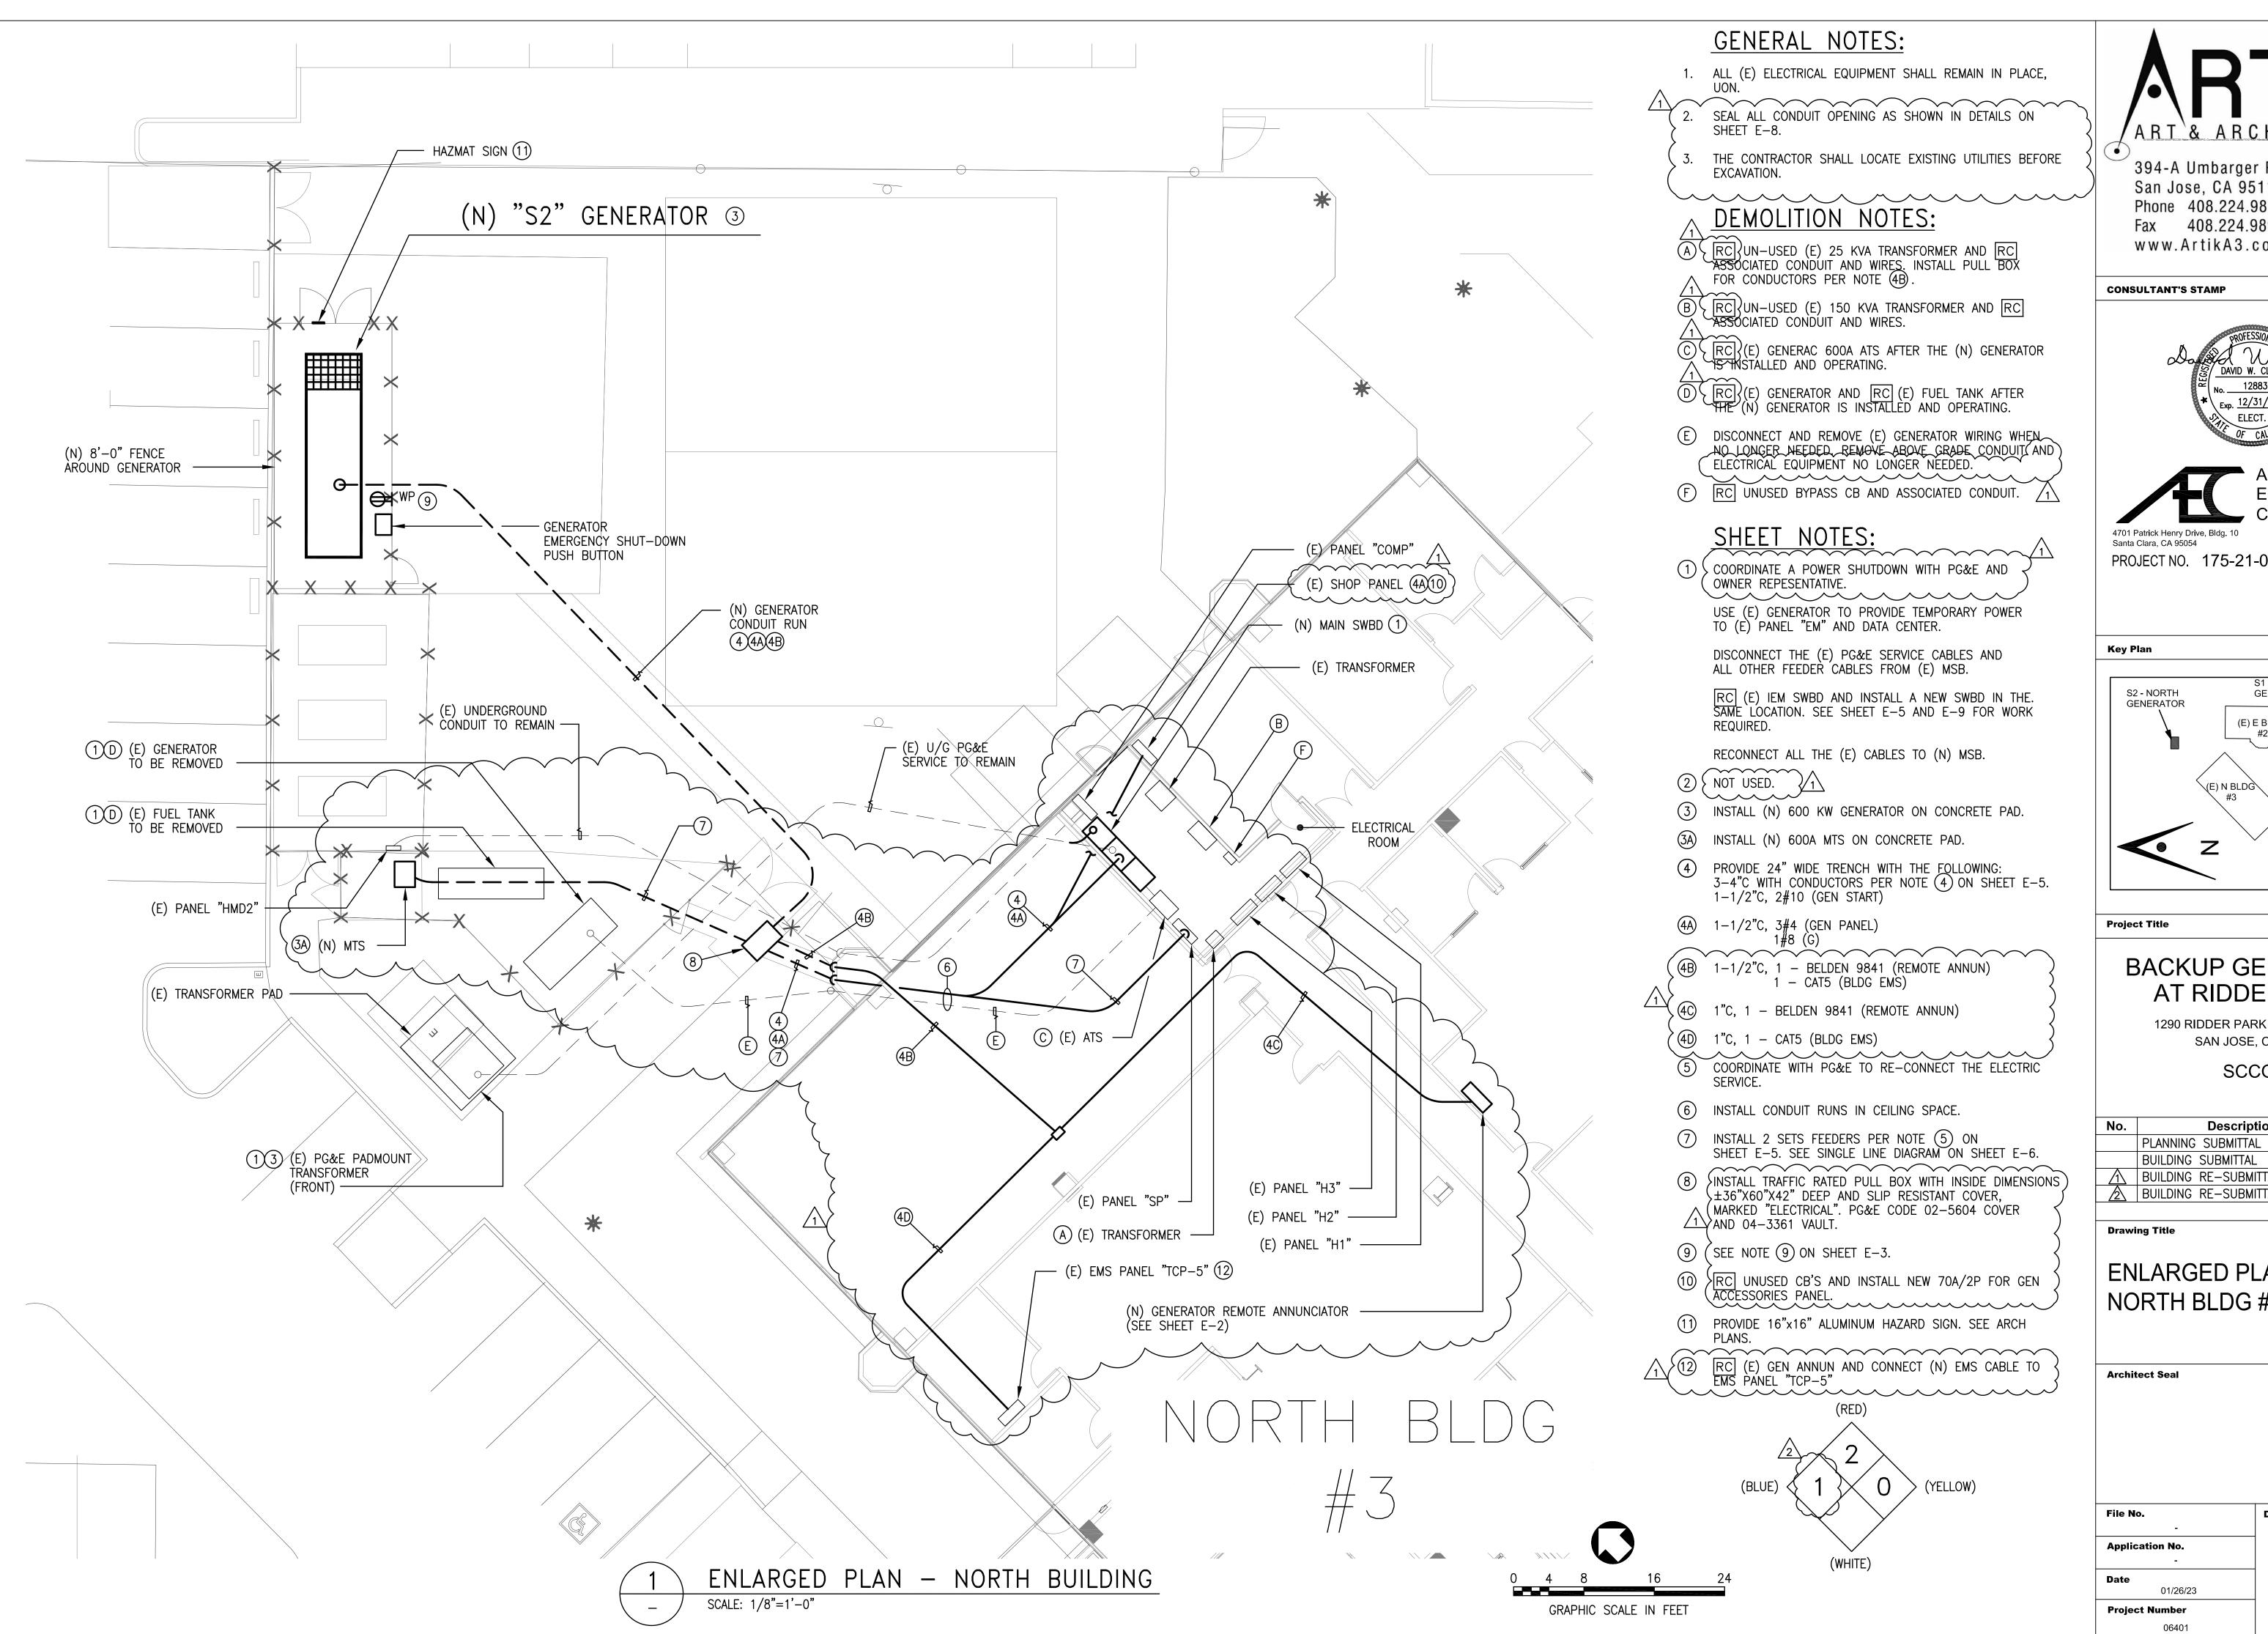

ART`& ARCHITECTURE 394-A Umbarger Rd San Jose, CA 95111 Phone 408.224.9890 Fax 408.224.9891 www.ArtikA3.com A WANTER 2low 12883 ∖ Exp. <u>12/31/24</u> ELECT. Alliance Engineering Consultants, Inc. phone (408) 970-9888 fax (408) 970-9316 PROJECT NO. 175-21-07 www.aec-engineers.com S1 - SOUTH GENERATOR (E) E BLDG #2 (E) S BLDG **BACKUP GENERATOR** AT RIDDER PARK 1290 RIDDER PARK DRIVE, MC 254 SAN JOSE, CA 95131 SCCOE Description Date 5/26/22 7/11/22 3/14/23 BUILDING RE-SUBMITTAL BUILDING RE-SUBMITTAL 5/19/23 ENLARGED PLAN -NORTH BLDG #3 SERVICE Drawing No. **E-4**

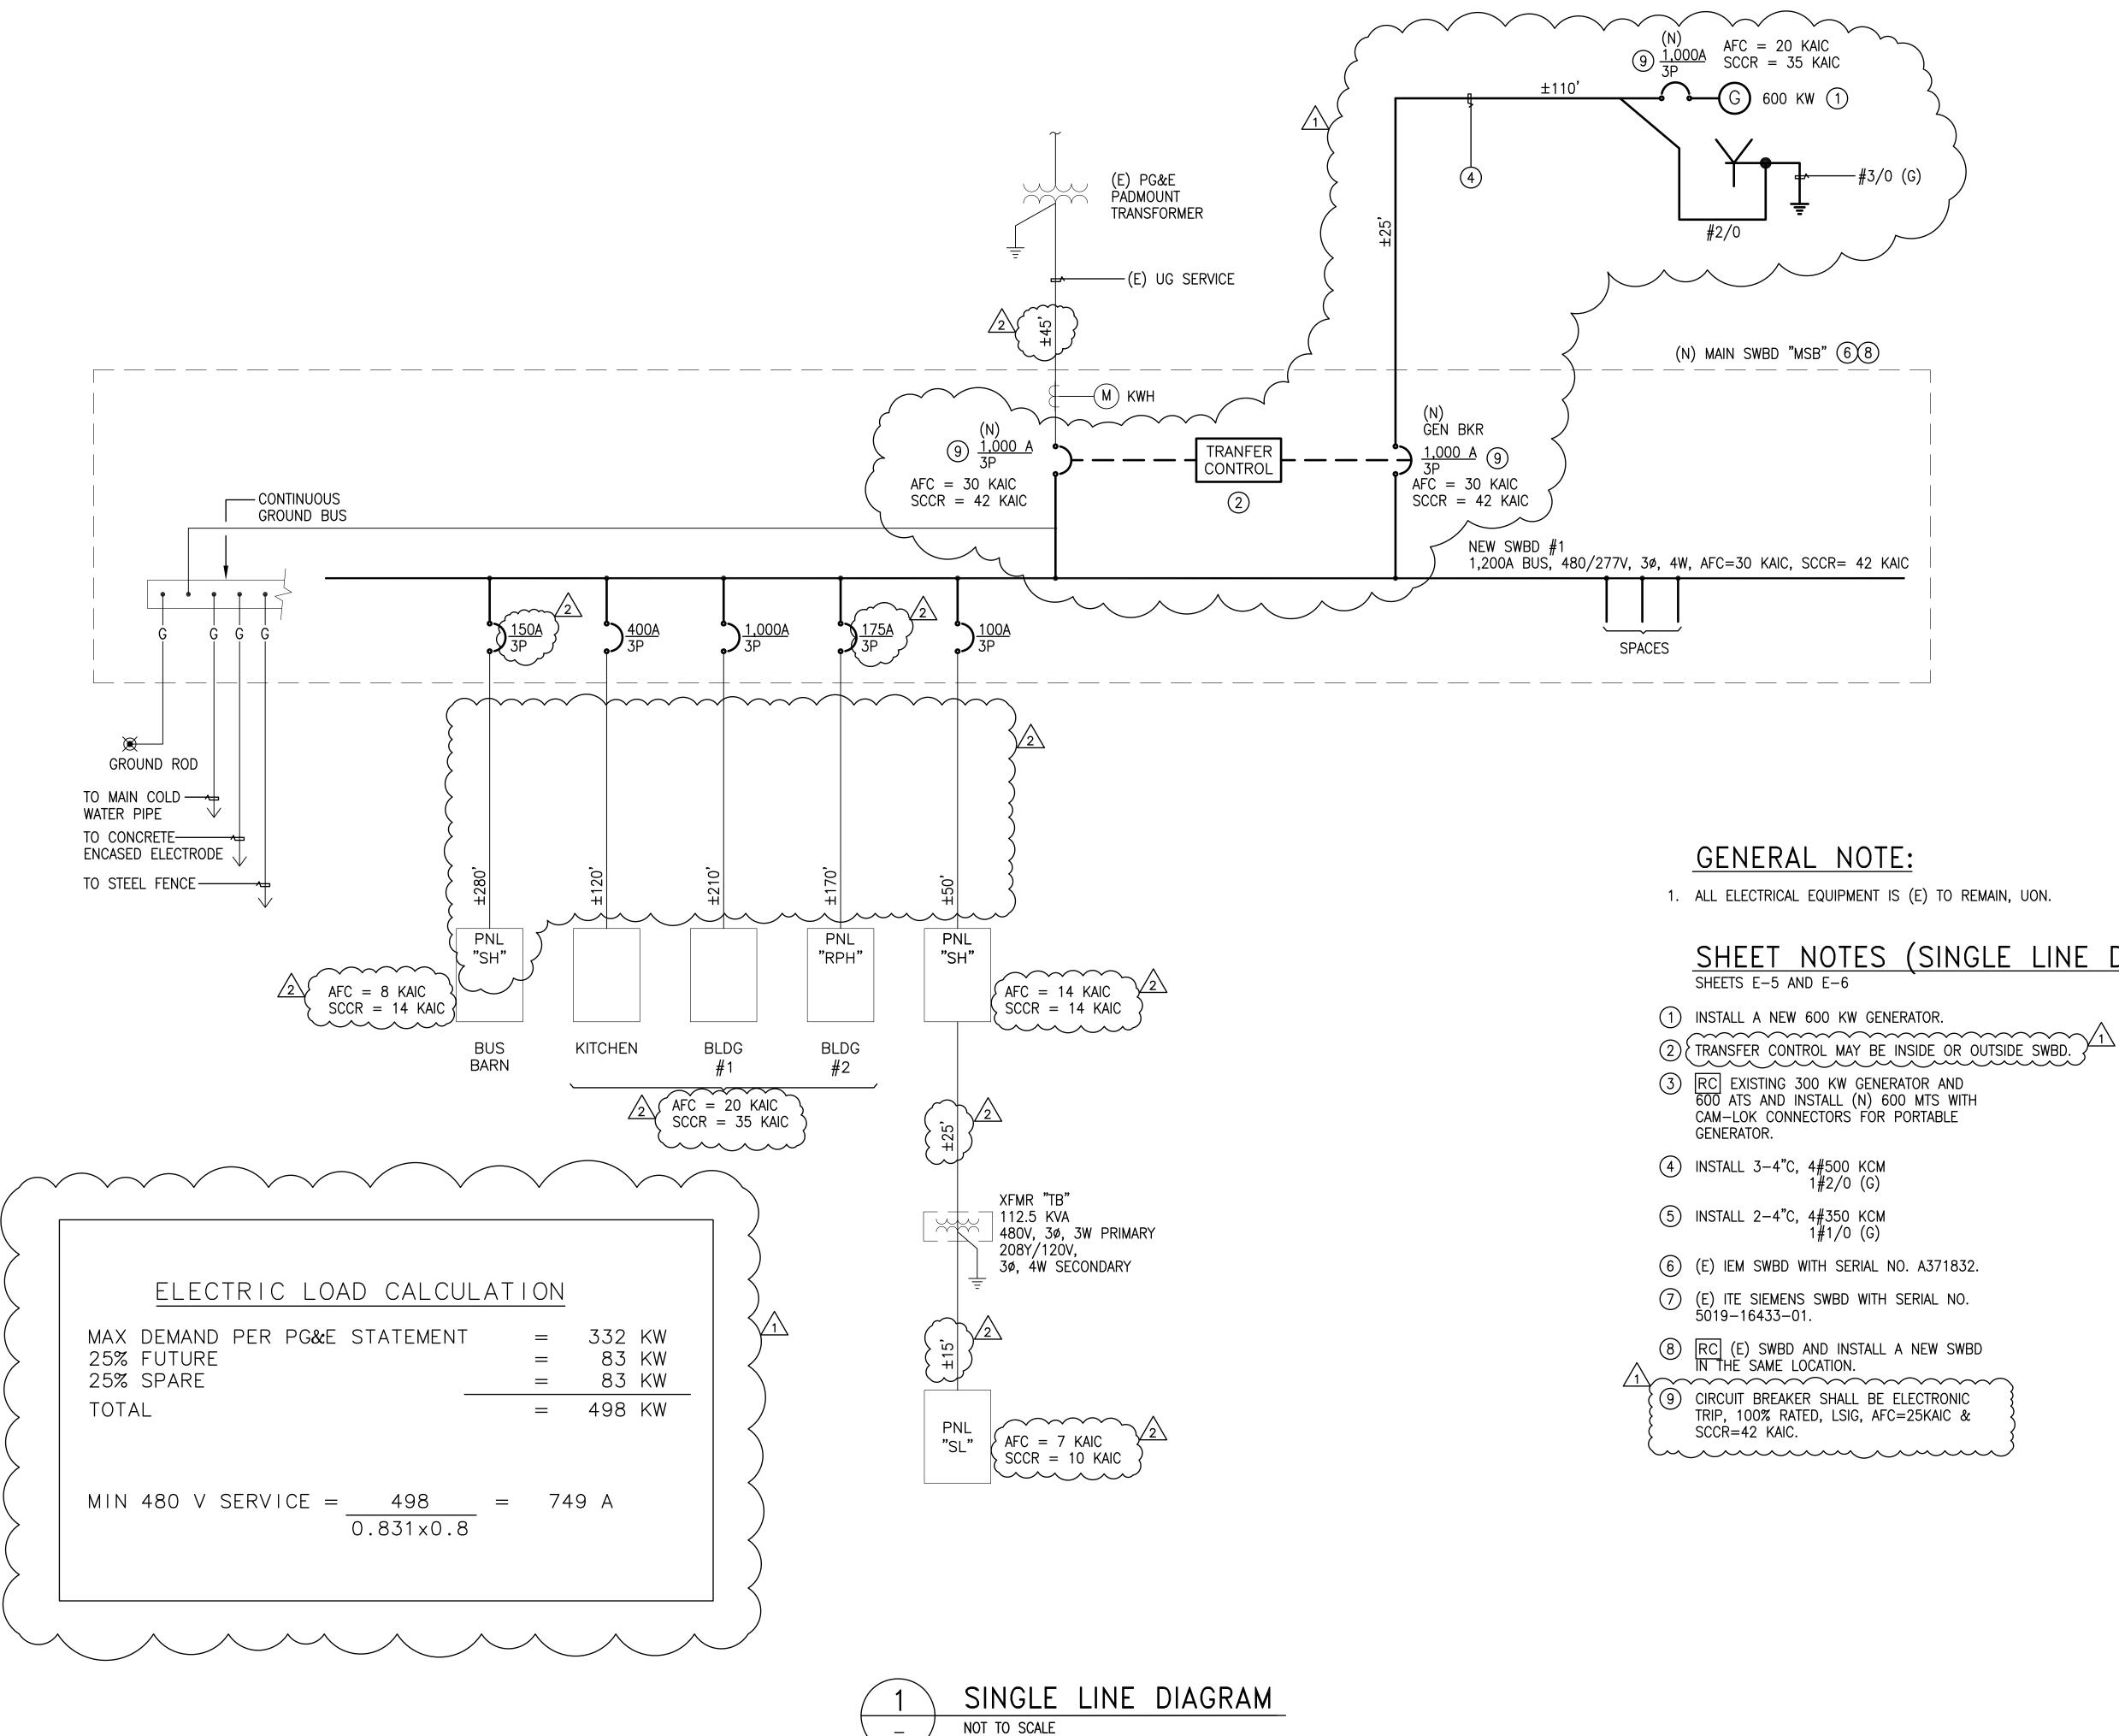



NOT TO SCALE


Z	
)	


SHEET NOTES (SINGLE LINE DIAGRAMS):


ART & ARCHITECTURE
• 394-A Umbarger Rd San Jose, CA 95111 Phone 408.224.9890 Fax 408.224.9891 www.ArtikA3.com
CONSULTANT'S STAMP
Avid W. CLOW No. 12883 * Exp. 12/31/24 ELECT. OF CALLORNIC Alliance Engineering
A701 Patrick Henry Drive, Bldg. 10 Santa Clara, CA 95054 PROJECT NO. 175-21-07 Consultants, Inc. phone (408) 970-9888 fax (408) 970-9316 www.aec-engineers.com
Key Plan
S1 - SOUTH GENERATOR (E) E BLDG #2
(E) N BLDG #3 (E) S BLDG
Project Title
BACKUP GENERATOR AT RIDDER PARK 1290 RIDDER PARK DRIVE, MC 254 SAN JOSE, CA 95131 SCCOE
No.DescriptionDatePLANNING SUBMITTAL5/26/22BUILDING SUBMITTAL7/11/22ABUILDING RE-SUBMITTAL3/14/23ABUILDING RE-SUBMITTAL5/19/23
Drawing Title
SINGLE LINE DIAGRAM BLDG #1
Architect Seal
File No. Drawing No.
- Application No.
Date E-5
Date

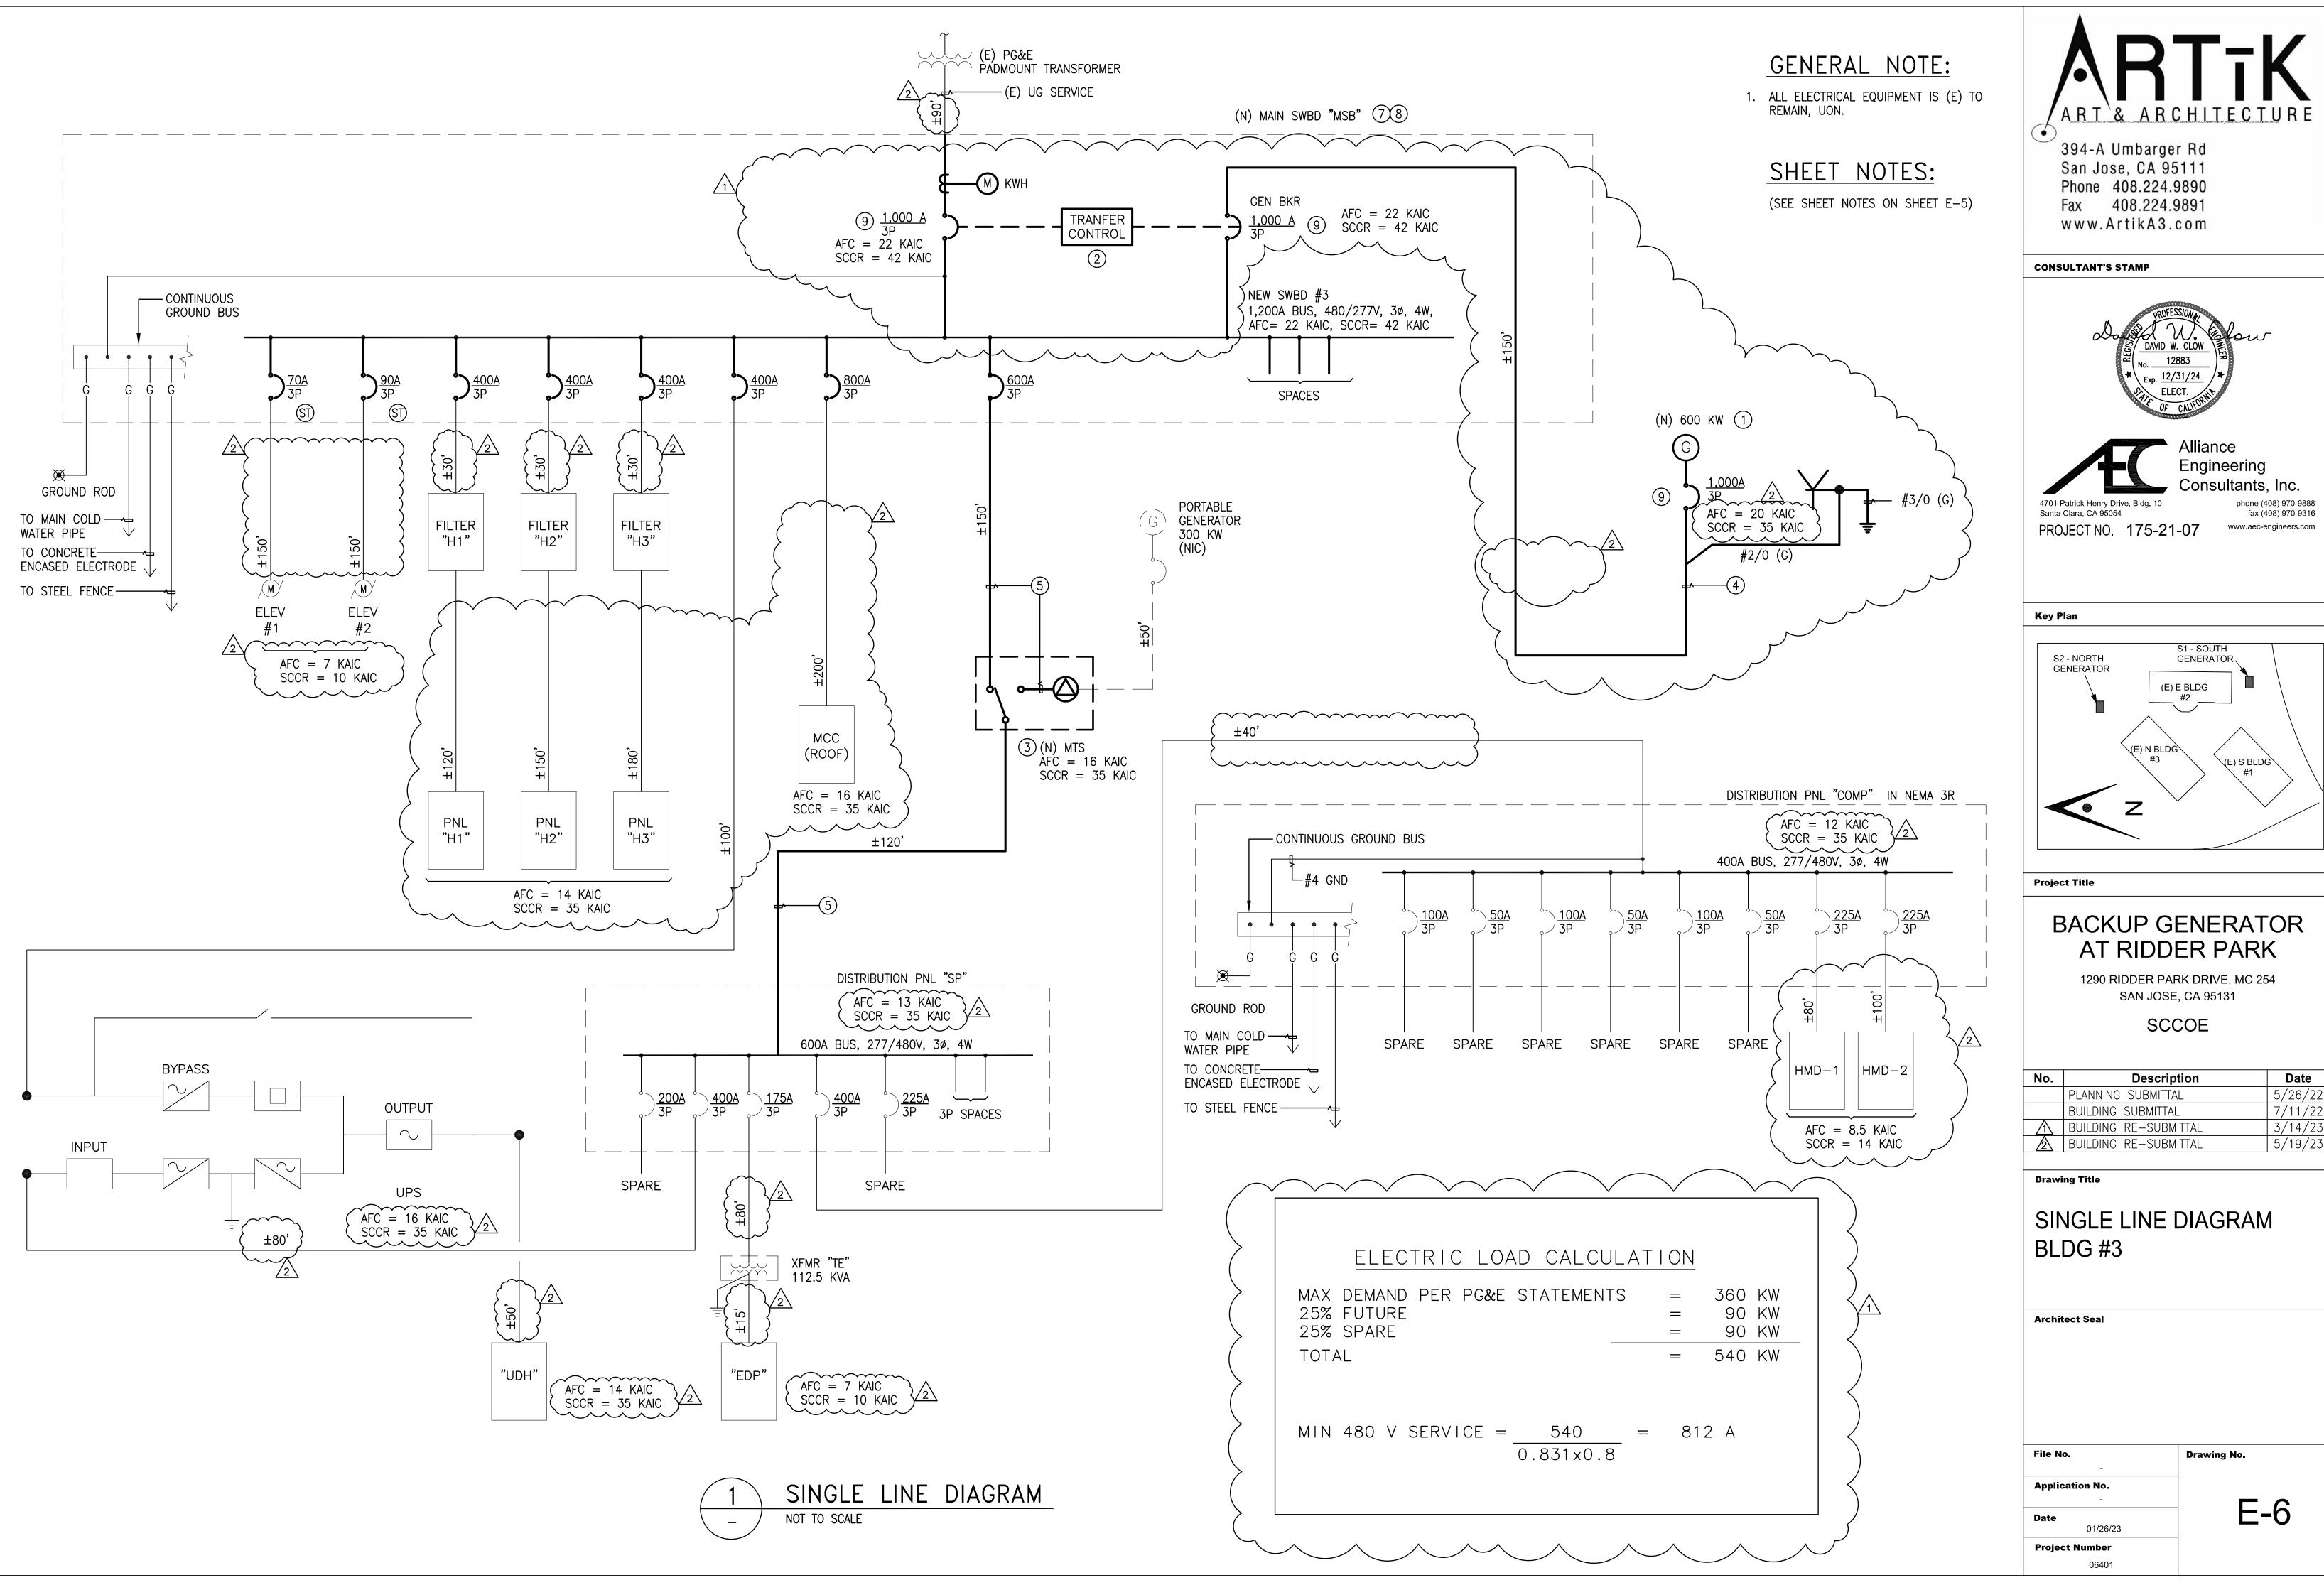


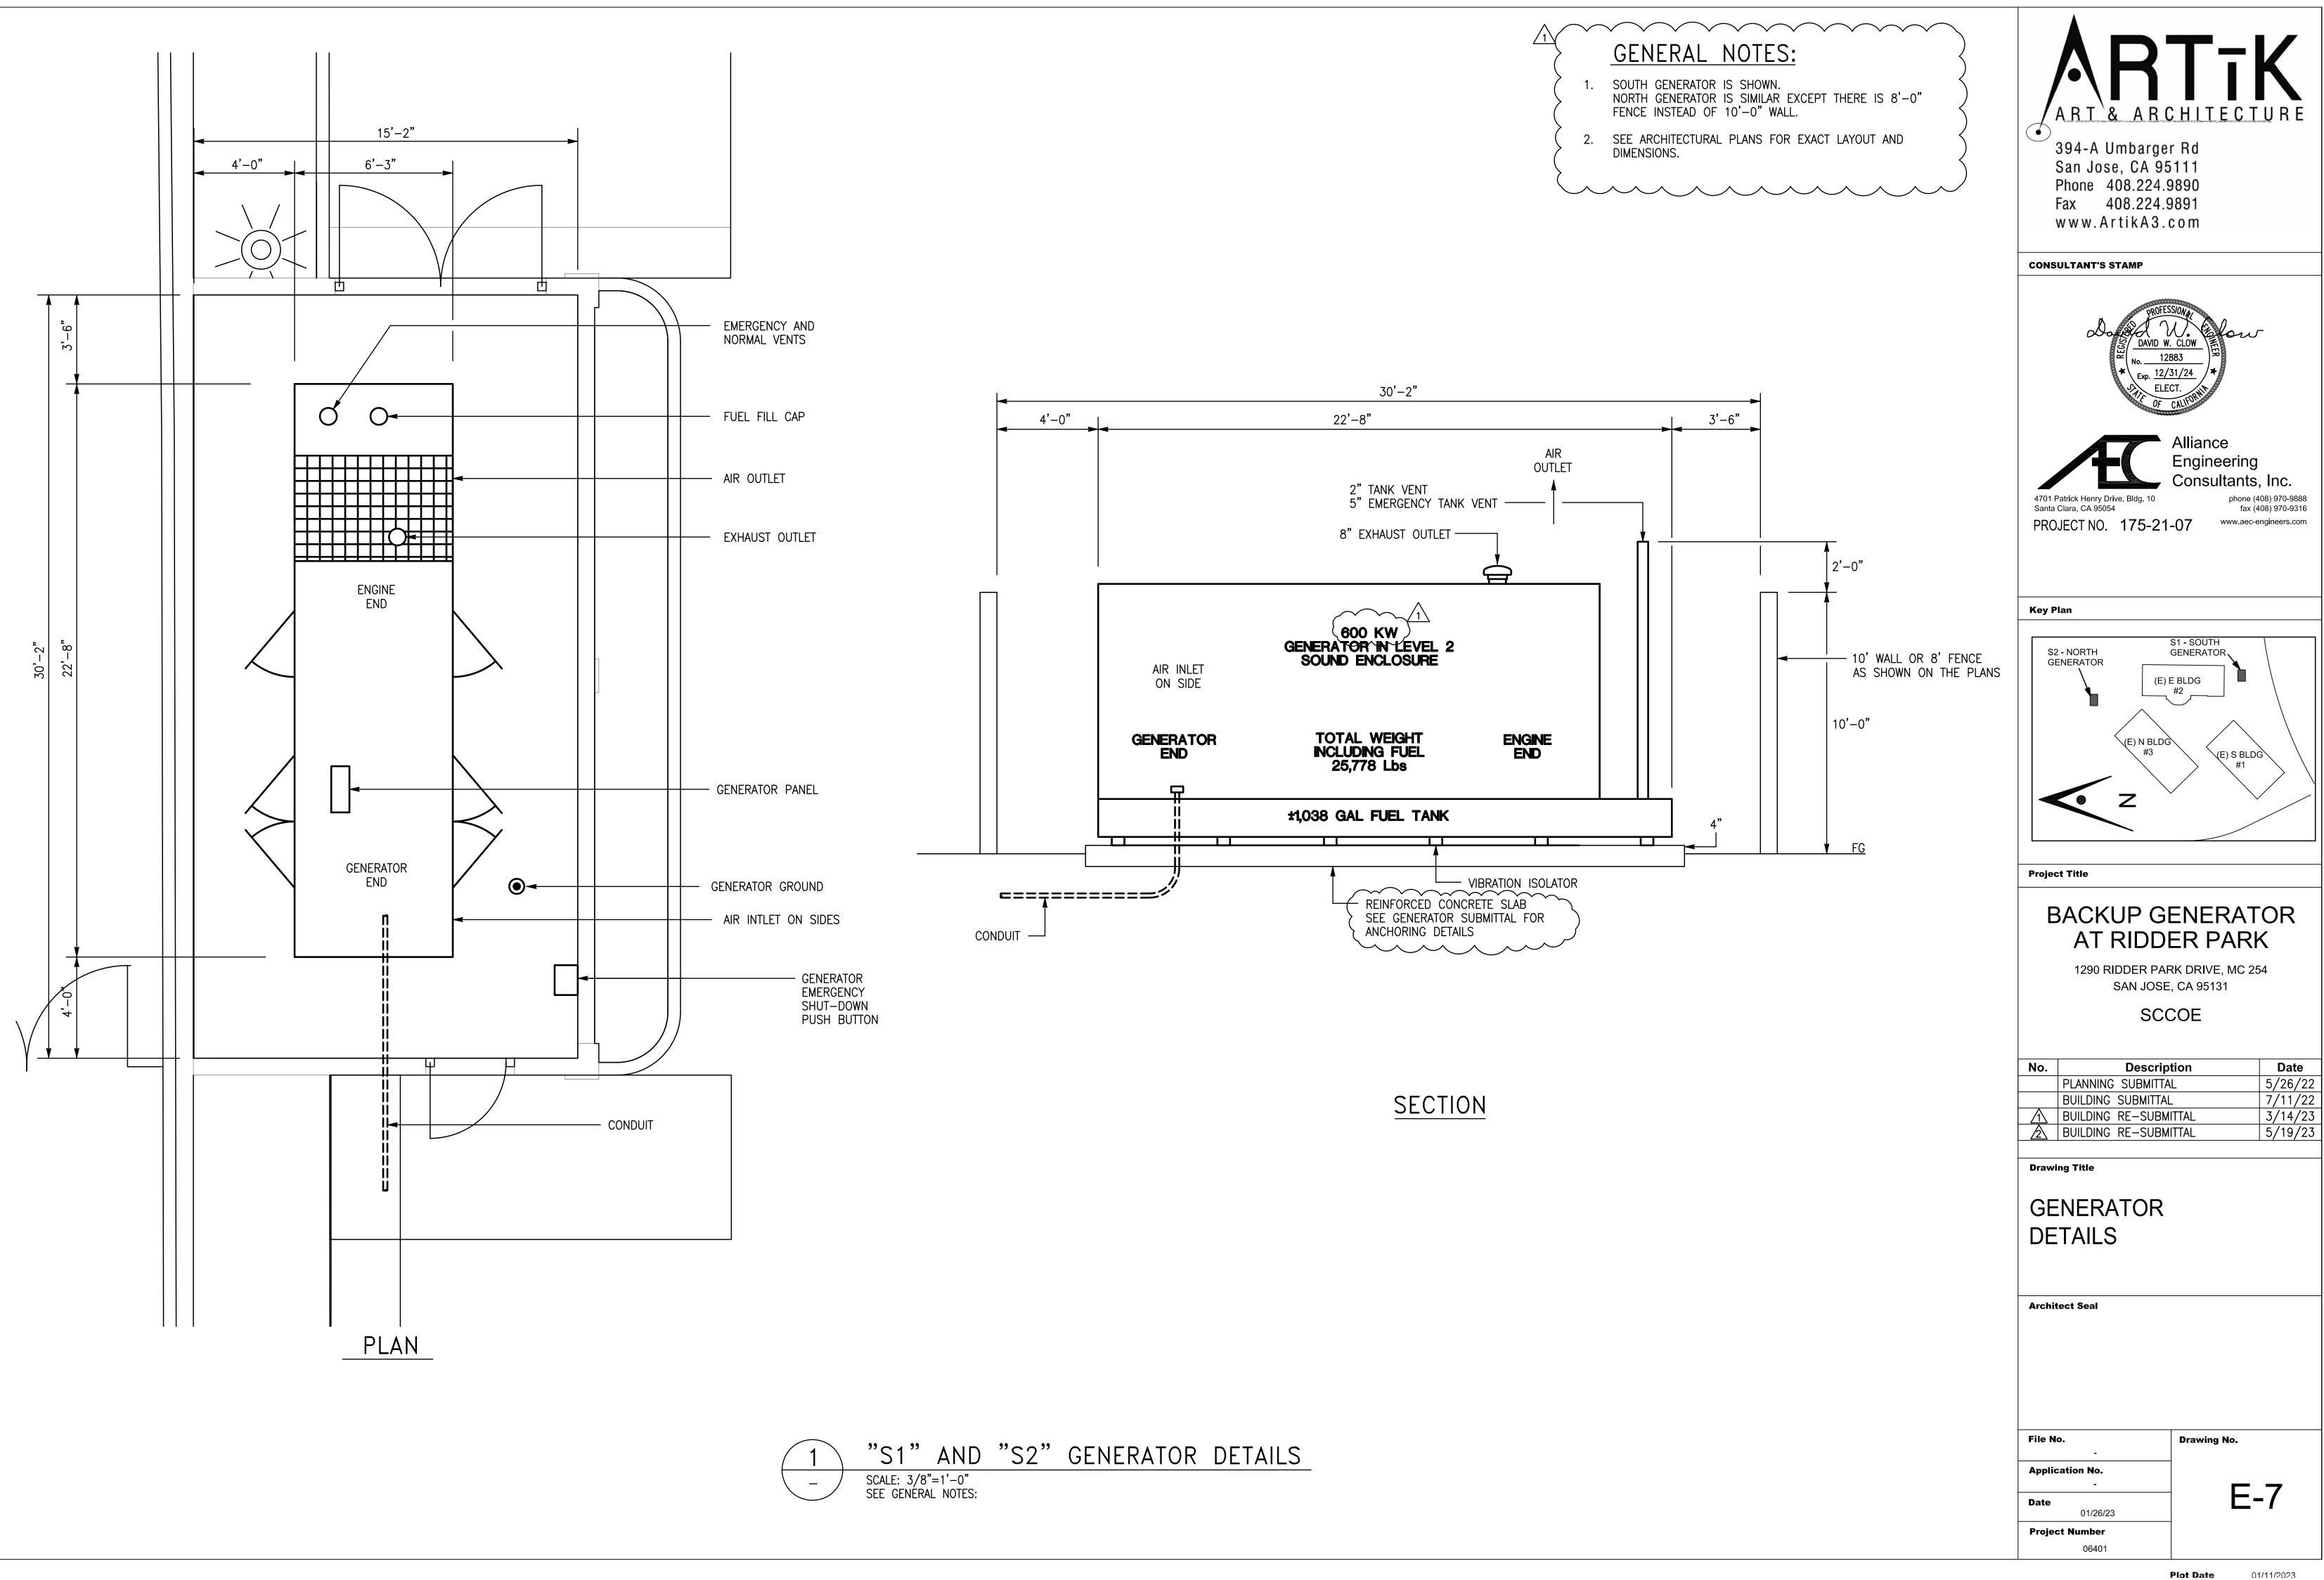


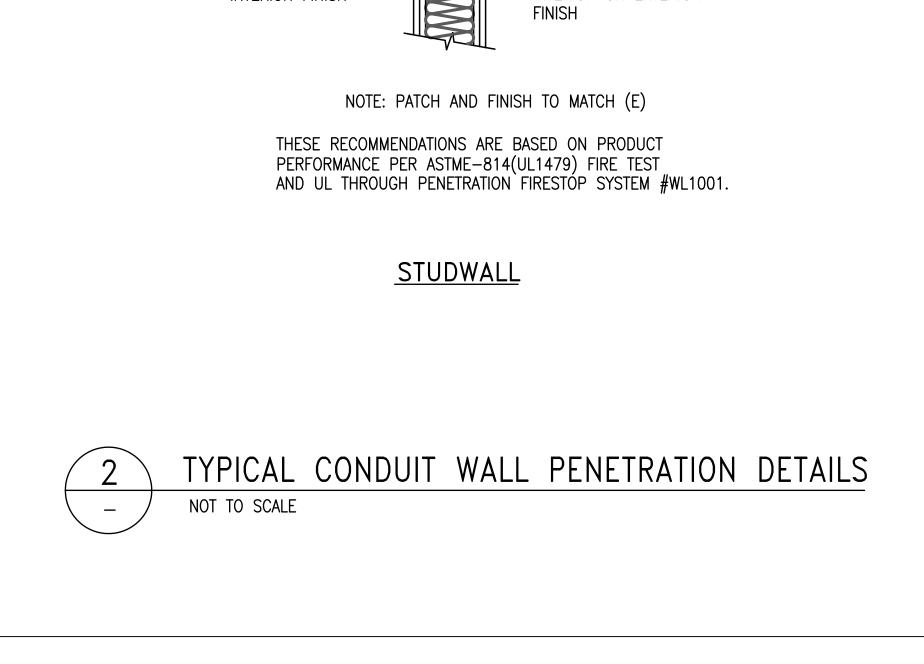

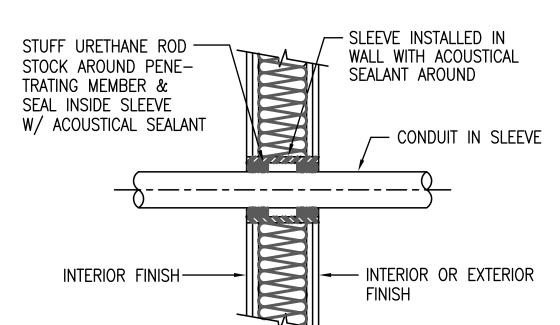

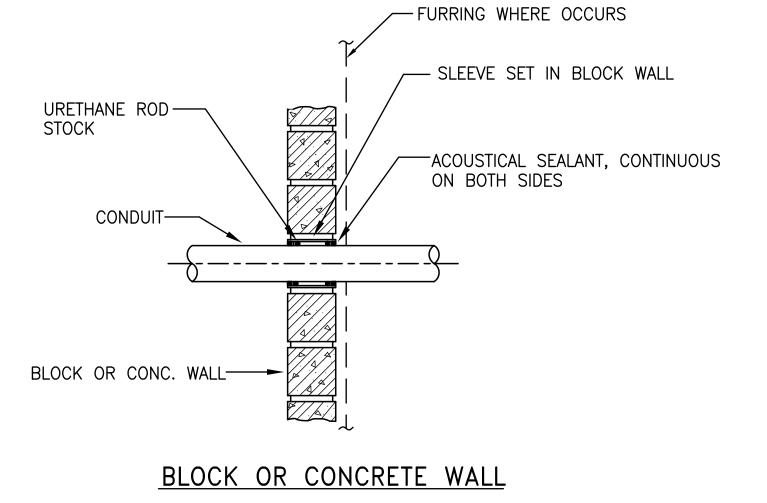

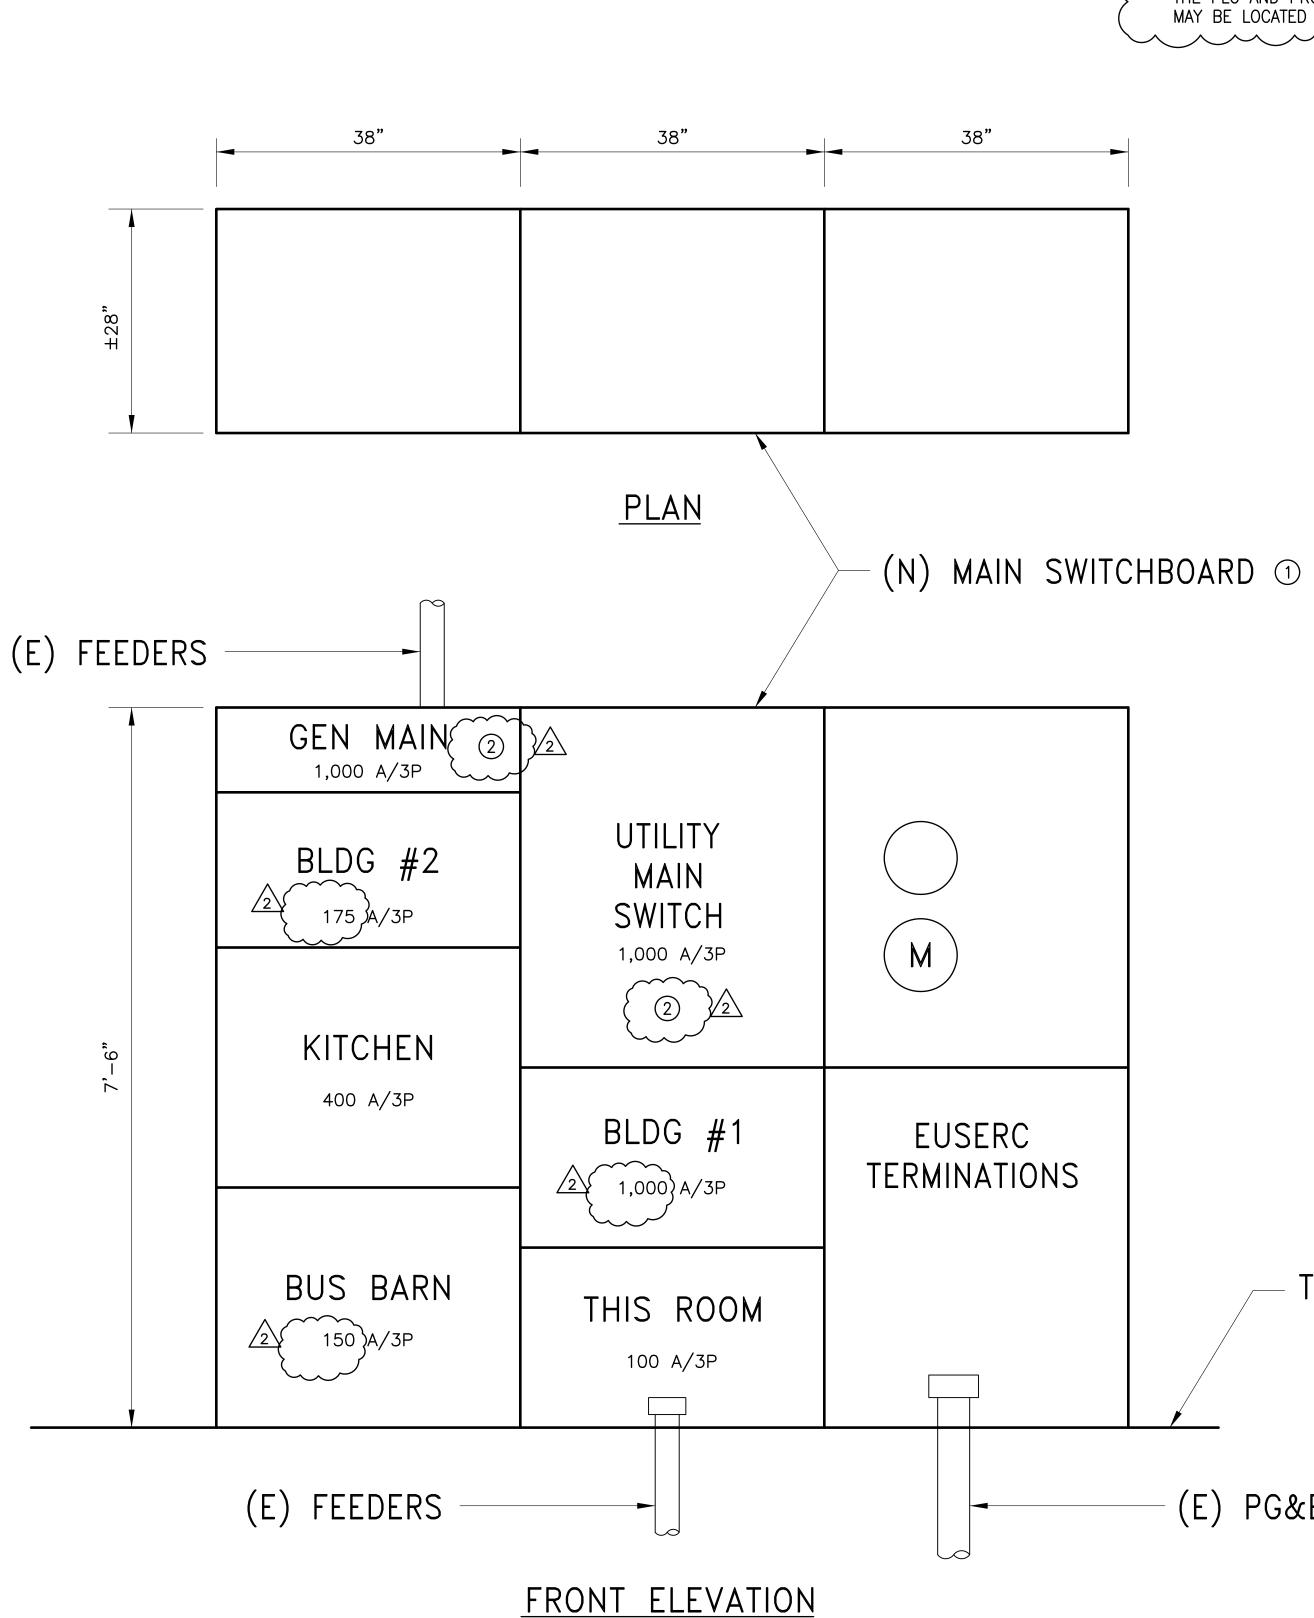

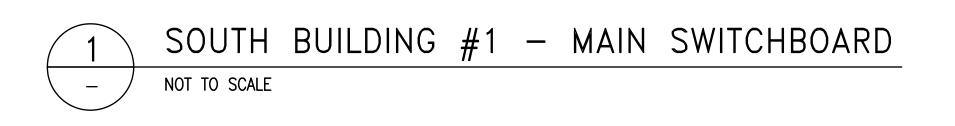

SHEET NOTE:

(1) RC EXISTING MAIN SWITCHBOARD AND INSTALL NEW MAIN SWITCHBOARD IN THE SAME LOCATION. SEE PLANS FOR DETAILS CIRCUIT BREAKERS WITH ELECTRICAL OPERATORS


THE PLC AND PROGRAMMED TRANSFER CONTROLS MAY BE LOCATED IN A SEPARATE CABINET.

TOP OF FLOOR

(E) PG&E SERVICE CONDUIT

ART -K
ART & ARCHITECTURE
394-A Umbarger Rd
San Jose, CA 95111 Phone 408.224.9890
Fax 408.224.9891 www.ArtikA3.com
CONSULTANT'S STAMP
DAVID W. CLOW No. 12883 * Exp. 12/31/24 SHIE OF CALIFORNIA
Alliance Engineering
4701 Patrick Henry Drive, Bldg. 10 phone (408) 970-9888
Santa Clara, CA 95054 fax (408) 970-9316 PROJECT NO. 175-21-07 www.aec-engineers.com
Key Plan
S1 - SOUTH S2 - NORTH GENERATOR GENERATOR
(E) E BLDG #2
(E) N BLDG #3 (E) S BLDG
#0 (E) S BLDG #1
Project Title
BACKUP GENERATOR
AT RIDDER PARK
1290 RIDDER PARK DRIVE, MC 254 SAN JOSE, CA 95131
SCCOE
No.DescriptionDatePLANNING SUBMITTAL5/26/22
BUILDING SUBMITTAL7/11/22ABUILDING RE-SUBMITTAL3/14/23ABUILDING RE-SUBMITTAL5/19/23
<u>Z</u> BUILDING RE-SUBMITIAL 5/19/23 Drawing Title
SWITCHBOARD
DETAILS
BUILDING #1
Architect Seal
File No Drawing No
Application No. Date
01/26/23

01/11/2023 Plot Date

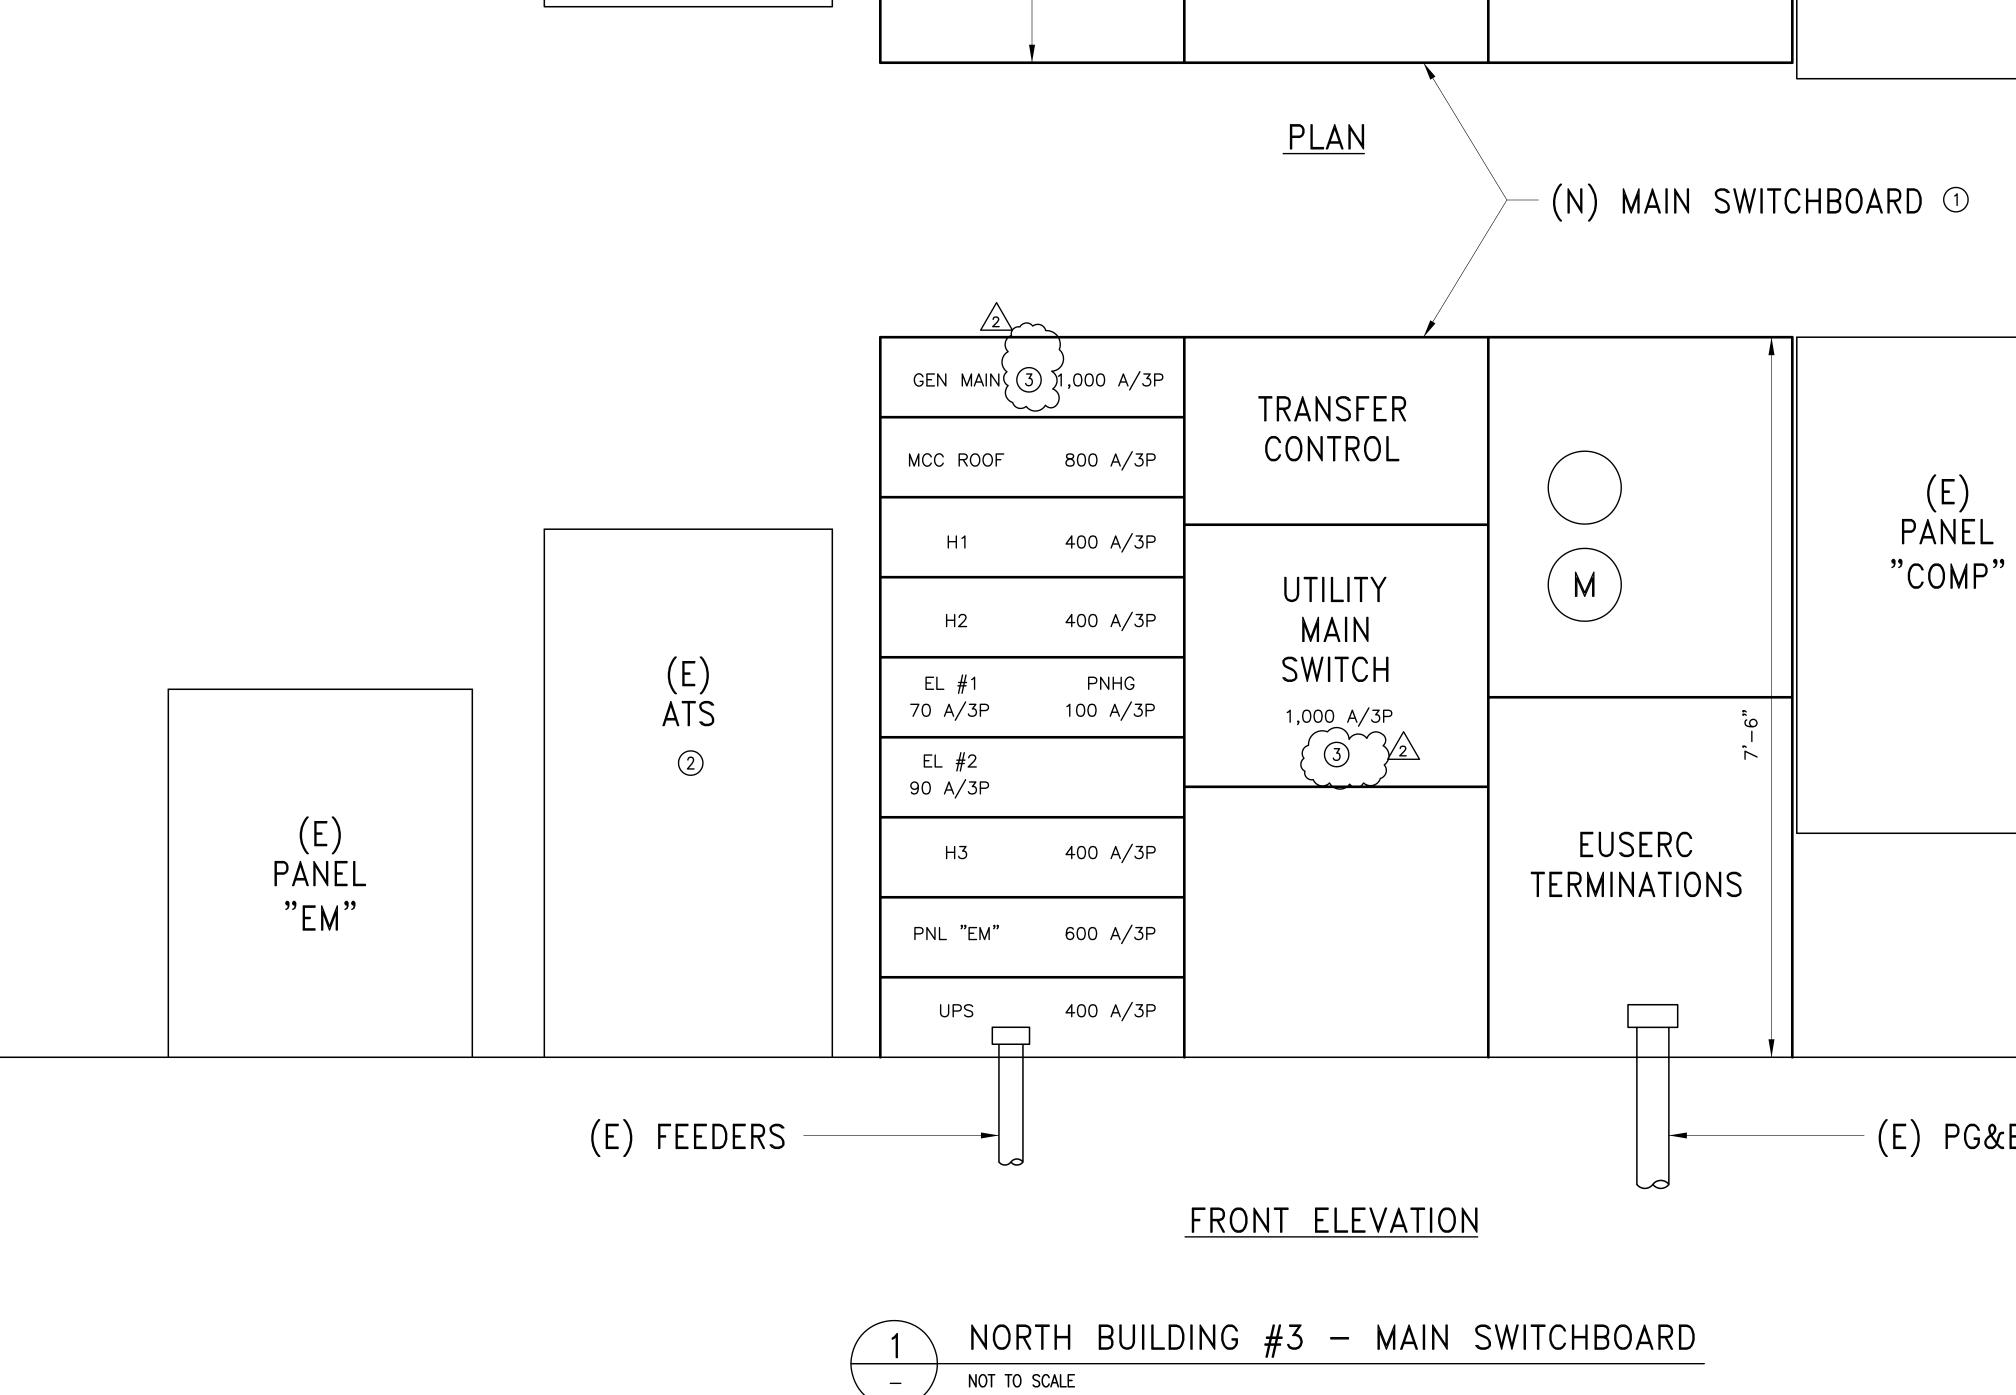

38"

00 Ň 38"

(2)

38"

SHEET NOTES:

1 RC EXISTING MAIN SWITCHBOARD AND INSTALL NEW MAIN SWITCHBOARD IN THE SAME LOCATION. SEE PLANS FOR DETAILS. EXISTING ATS SHALL REMAIN IN OPERATION UNTIL THE NEW PROGRAMMED TRANSFER CONTROL IS COMMISSIONED AND IN OPERATION AND THEN REMOVE. (3) CIRCUIT BREAKERS WITH ELECTRICAL OPERATORS.

TOP OF FLOOR

(E) PG&E SERVICE CONDUIT

T		
ART&ARC 394-A Umbarge San Jose, CA 95 Phone 408.224.9 Fax 408.224.9 www.ArtikA3.	5111 9890 9891	K U R E
CONSULTANT'S STAMP		
→ → → → → → → → → → → → → → → → → → →	Alliance Engineering Consultants	
Key Plan		
S2 - NORTH GENERATOR (E) (E) N BLDG #3	S1 - SOUTH GENERATOR E BLDG #2 (E) S BLD0 #1	
Project Title		
BACKUP G AT RIDD 1290 RIDDER PAR SAN JOSE	ER PARI	<
No. Descrip		Date
PLANNING SUBMITTA BUILDING SUBMITTAI		5/26/22 7/11/22
BUILDING RE-SUBM		3/14/23 5/19/23
Drowing Title		
Urawing little		
Drawing Title SWITCHBOAR DETAILS BUILDING #3 Architect Seal	2D	
SWITCHBOAR DETAILS BUILDING #3	2D Drawing No.	
SWITCHBOAR DETAILS BUILDING #3 Architect Seal	Drawing No.	
SWITCHBOAR DETAILS BUILDING #3 Architect Seal		-9}

Plot Date 01/11/2023



May 15, 2023

AECEngineers Attn: Dave & Sudha

Re: Fault Current Request for 1290 Ridder Park Dr, San Jose – North Building

To Whom It May Concern,

This letter is regarding your recent request about the available short circuit duty at the above location. The available short circuit duty from the PG&E system will not exceed 22,000 Amperes 3 phase RMS symmetrical.

These short circuit duty calculations include the following conditions:

- 1. The secondary service voltage of 277/480 Volt, 3-Phase, 4 Wire from PG&E.
- 2. The building's ultimate electric demand reaches but does not exceed present main switch size of 1200 amps and the service length will be no greater than approximately 90' feet.

Any increase in the power main switch over which we have no control would change this calculated value, and the 22,000 Amperes short circuit duty would no longer be valid.

If you have any questions, please call me at (408) 598-6987

Sincerely,

Daniel Wong

Daniel Wong Senior New Business Representative

> 308 Stockton Avenue, San Jose, CA 95126 | 408-299-9500 Main | 408-299-9509 Fax Public



May 15, 2023

AECEngineers Attn: Dave & Sudha

Re: Fault Current Request for 1290 Ridder Park Dr, San Jose – South Building

To Whom It May Concern,

This letter is regarding your recent request about the available short circuit duty at the above location. The available short circuit duty from the PG&E system will not exceed 30,000 Amperes 3 phase RMS symmetrical.

These short circuit duty calculations include the following conditions:

- 1. The secondary service voltage of 277/480 Volt, 3-Phase, 4 Wire from PG&E.
- 2. The building's ultimate electric demand reaches but does not exceed present main switch size of 1200 amps and the service length will be no greater than approximately 45' feet.

Any increase in the power main switch over which we have no control would change this calculated value, and the 30,000 Amperes short circuit duty would no longer be valid.

If you have any questions, please call me at (408) 598-6987.

Sincerely,

Daniel Wong

Daniel Wong Senior New Business Representative

ART & ARCHITECTURE 394-A Umbarger Rd San Jose, CA 95111 Phone 408.224.9890 Fax 408.224.9891 www.ArtikA3.com
CONSULTANT'S STAMP
DAVID W. CLOW No. 12883 * Exp. 12/31/24 OF CALIFORNIA
Alliance Engineering Consultants, Inc. Ator Patrick Henry Drive, Bldg. 10 Santa Clara, CA 95054 PROJECT NO. 175-21-07
Key Plan
S2 - NORTH GENERATOR (E) E BLDG #2 (E) N BLDG #3 (E) S BLDG #1 Z
Project Title
BACKUP GENERATOR AT RIDDER PARK DRIVE, MC 254 SAN JOSE, CA 95131 SCCOE
No.DescriptionDatePLANNING SUBMITTAL5/26/22
BUILDING SUBMITTAL3/20/22A BUILDING RE-SUBMITTAL7/11/22A BUILDING RE-SUBMITTAL3/14/23
BUILDING RE-SUBMITTAL 5/19/23
Drawing Title PG&E SHORT CIRCUIT LETTERS
Architect Seal
File No. Drawing No.
Application No. Date E-10
01/26/23 Project Number 06401

Plot Date

01/11/2023